




BOR Drawing Number:
27-418-60041-MF-1

KEN R. BERG, P.E.
DRAWN

JEREMY FOWLER, P.E.
ACCEPTED

418 (PROVO, UT) 2023-11-08

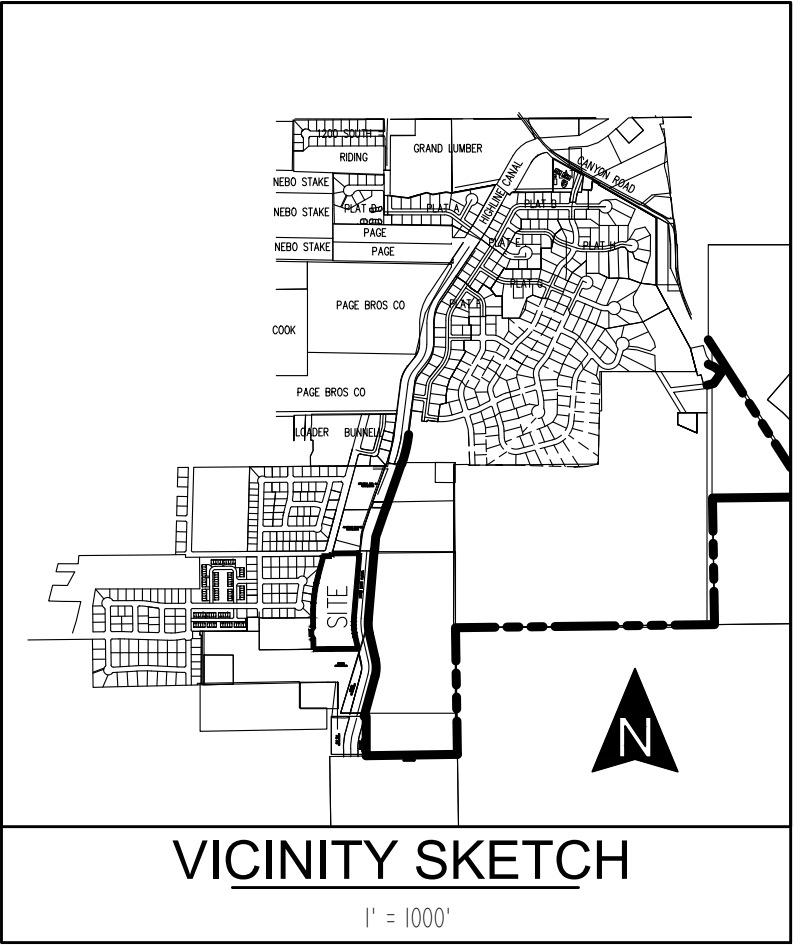


CONSTRUCTION NOTES		
ALL CONSTRUCTION TO CONFORM TO PAYSON CITY OR APWA STANDARD DETAILS		
ABBREVIATION KEY		
BOW	BACK OF SIDEWALK	
CB	CATCH BASIN	
EOA	EDGE OF ASPHALT	
FL	FLOWLINE	
FF	FINISHED FLOOR ELEVATION	
HP	HIGH POINT	
LP	LOW POINT	
RM	MANHOLE RIM OR CATCH BASIN GRATE	
TBC	TOP BACK OF CURB	
SHEET INDEX		
C0	COVER SHEET	
C1	LAYOUT	
C2.1	WATER PLAN	
C2.2-C2.3	SEWER PLAN	
C2.4	POWER PLAN	
C2.5	FIRE PLAN	
C3.1	GRADING & DRAINAGE PLAN	
C3.2	TEMP SD RETENTION POND & CALCS	
C4.1-C4.4	1900 SOUTH PLAN & PROFILE	
C5.1-C5.2	MAIN STREET PLAN & PROFILE	
C6.1	100 EAST PLAN & PROFILE	
C7.1	1860 SOUTH PLAN & PROFILE	
GNI	GENERAL NOTES	
DTL1-DTL2	CONSTRUCTION DETAILS	
CONTACT LIST		
CIVIL ENGINEER	BERG CIVIL ENGINEERING	(801) 492-1277
GEOTECHNICAL ENGINEER		


DEVELOPMENT

PAYSON
VIEW
ESTATES
PHASE 4


DEVELOPER




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Highland, UT 84003
(801) 642-0119

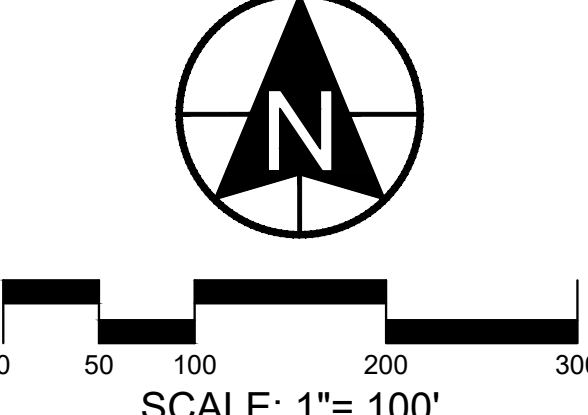

SCALE: 1"= 100'



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office (801) 492-1277
cell (801) 616-1677

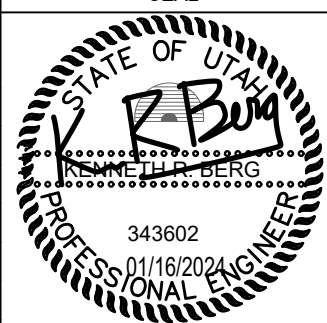REVISIONS			SEAL
NO.	DATE	DESCRIPTION	
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ACTION		DATE	
PRELIM		01/16/2024	

PROJECT

PAYSON VIEW
ESTATES
PHASE 4

DESCRIPTION

PRELIMINARY
PLANS


SHEET NAME	SHEET NUMBER
COVER	C0



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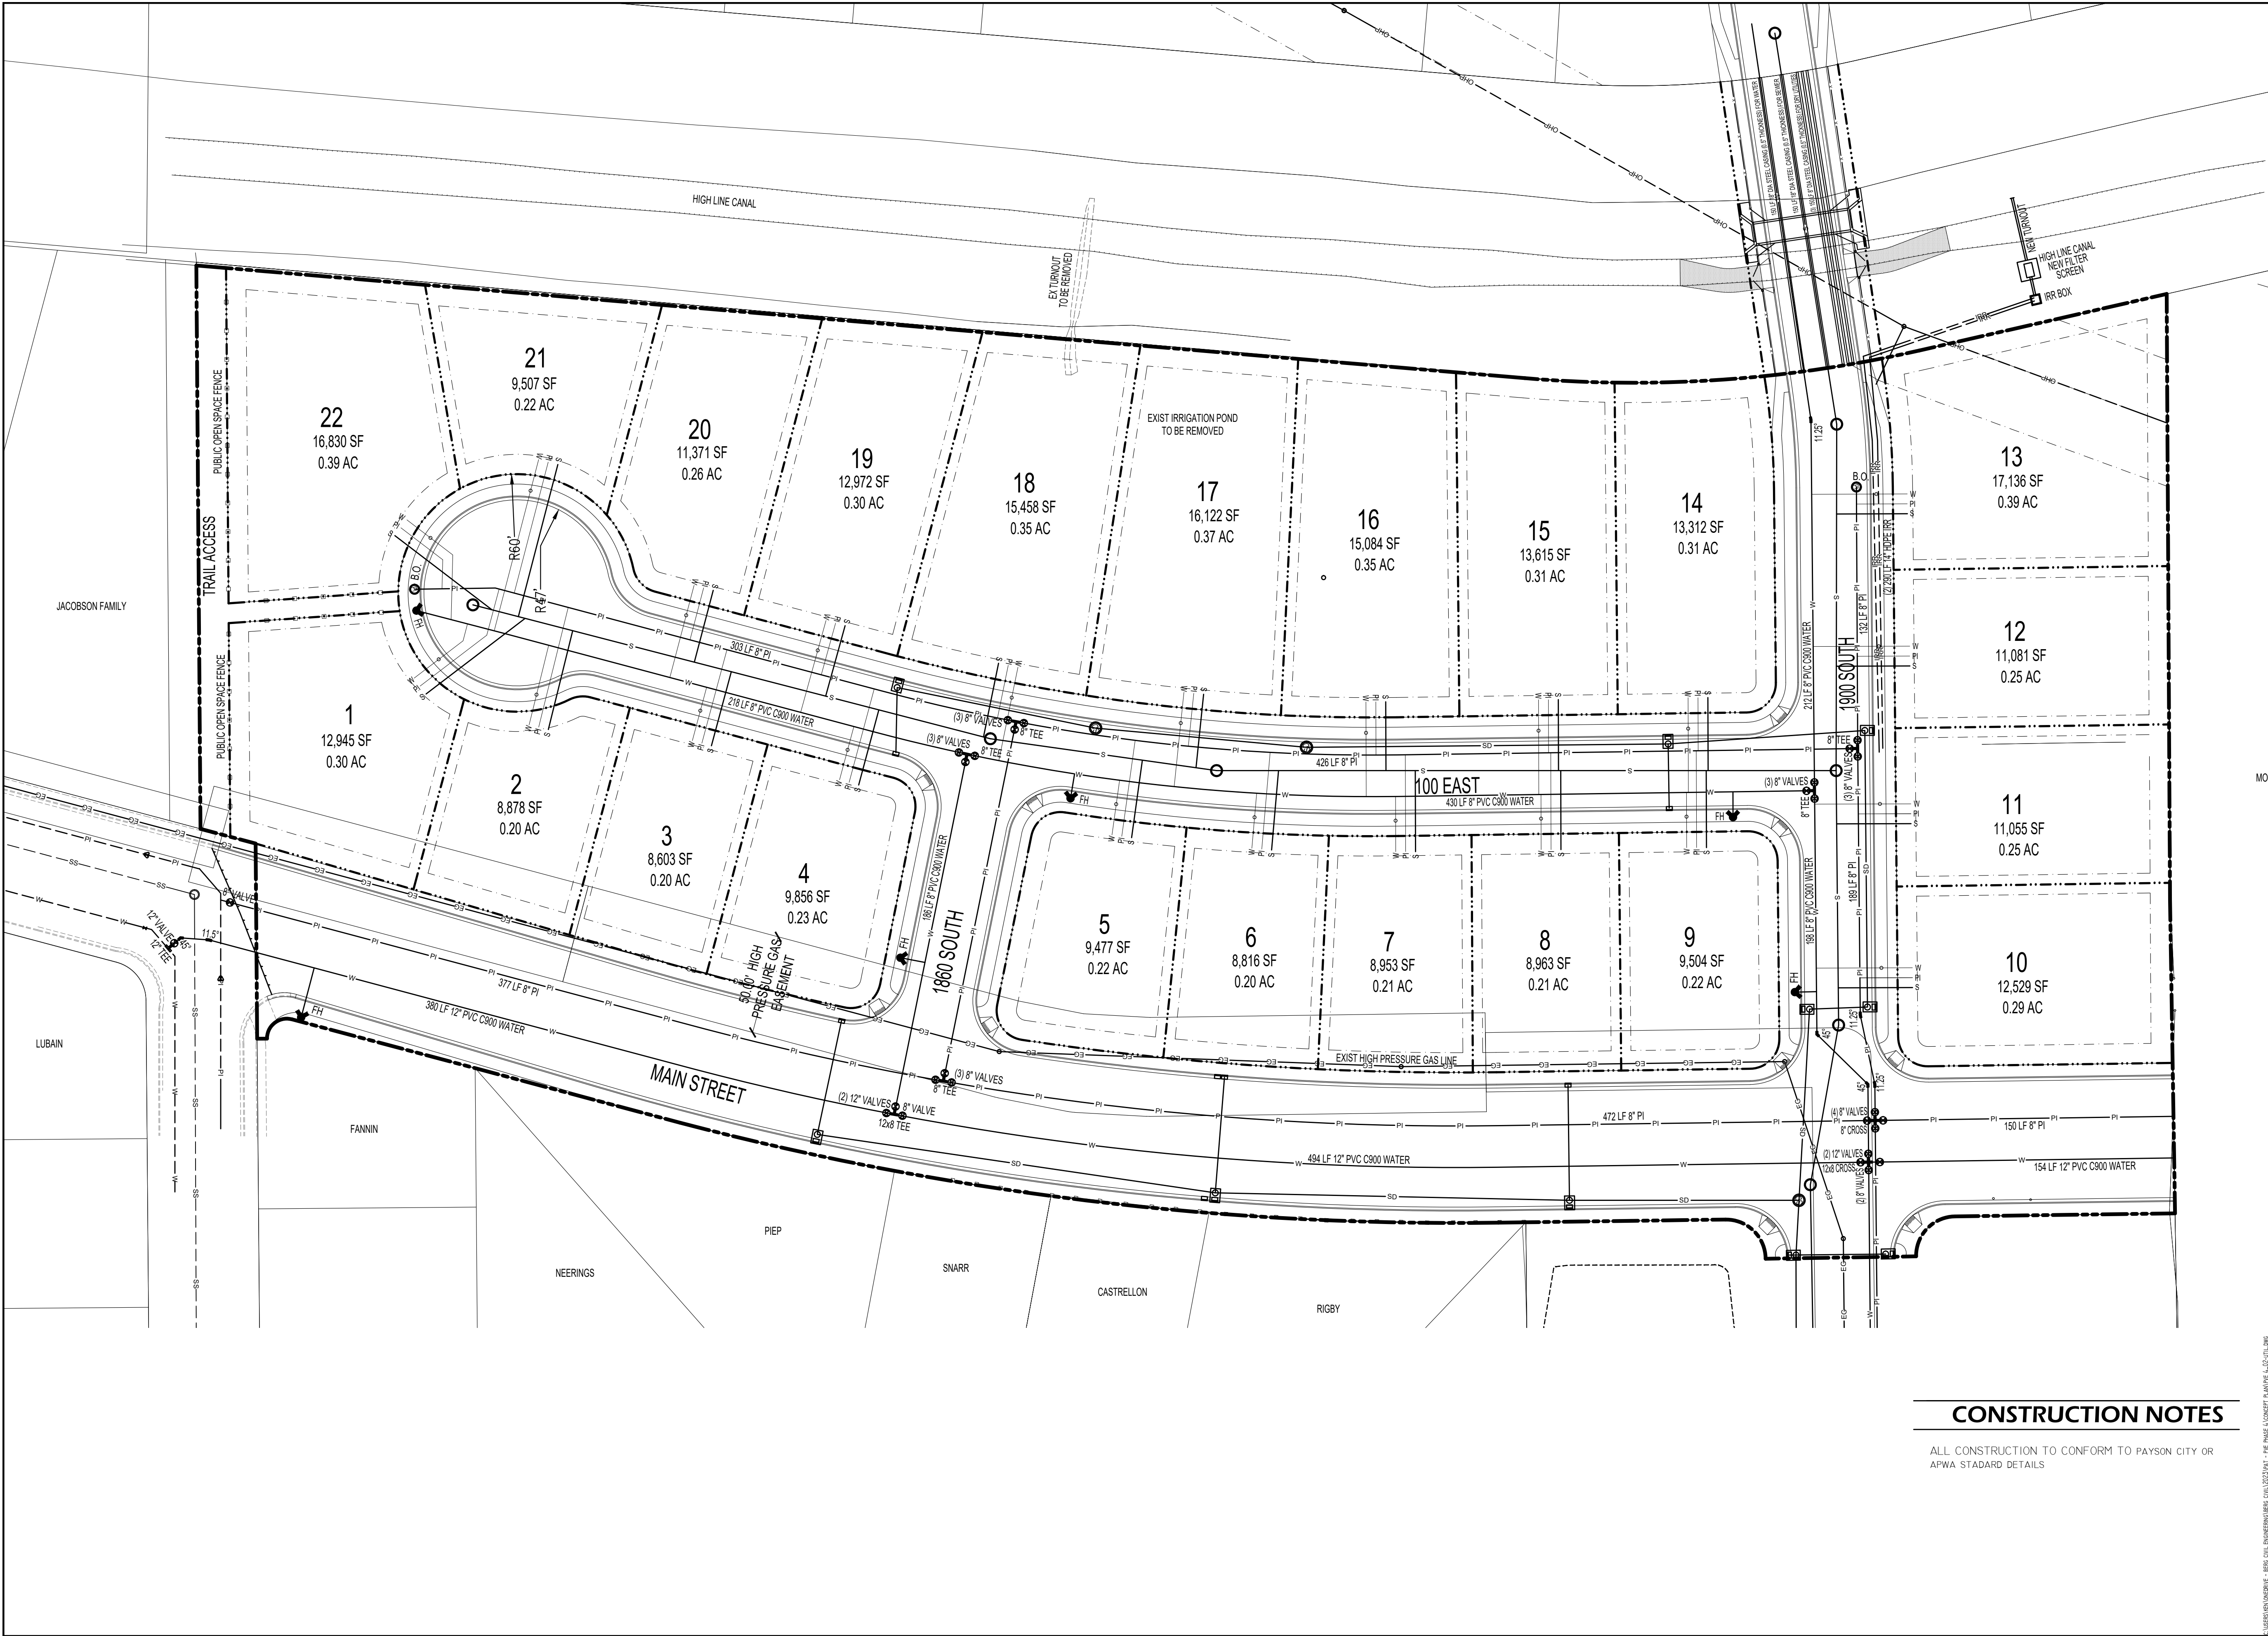
KENNETH R. BERG
 _____ P.
 SERIAL NO. 343502
 DATE: 01/16/2024

ACTION	DATE
PRELIM	01/16/2024

*PAYSON VIEW
ESTATES
PHASE 4*

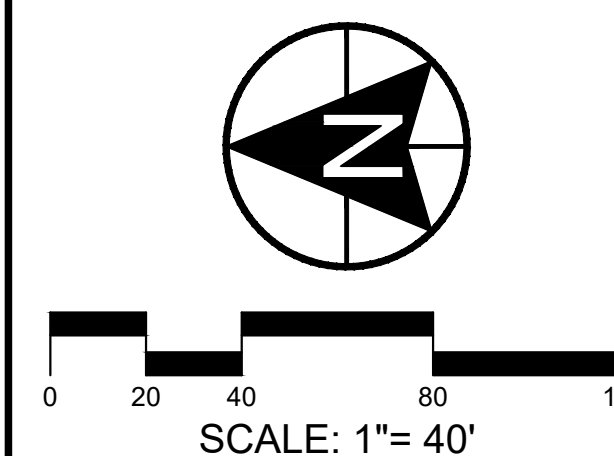PRELIMINARY PLANS


SHEET NAME	SHEET NUMBER
LAYOUT	C1



DEVELOPMENT


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PHASE 4

DEVELOPER




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SCALE: 1"= 40'

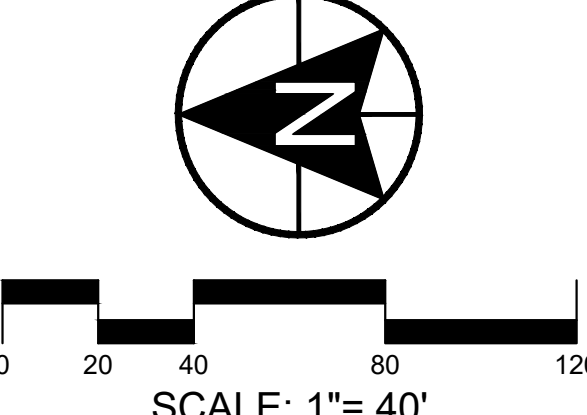

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ACTION	DATE
PRELIM	01/16/2024

PROJECT

PAYSON VIEW
ESTATES
PHASE 4

DESCRIPTION

PRELIMINARY
PLANS

SHEET NAME	SHEET NUMBER
WATER	C2.1

CONSTRUCTION NOTES

ALL CONSTRUCTION TO CONFORM TO PAYSON CITY OR APWA STANDARD DETAILS



CONSTRUCTION NOTES

ALL CONSTRUCTION TO CONFORM TO PAYSON CITY OR
APWA STADARD DETAILS


DEVELOPMENT

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0 20 40 80 120
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PRELIM			01/16/2024

PROJECT


**PAYSON VIEW
ESTATES
PHASE 4**

DESCRIPTION

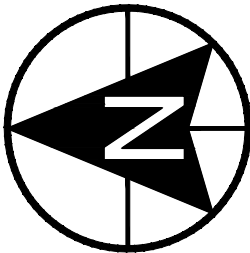**PRELIMINARY
PLANS**

SHEET NAME SHEET NUMBER

SEWER C2.2

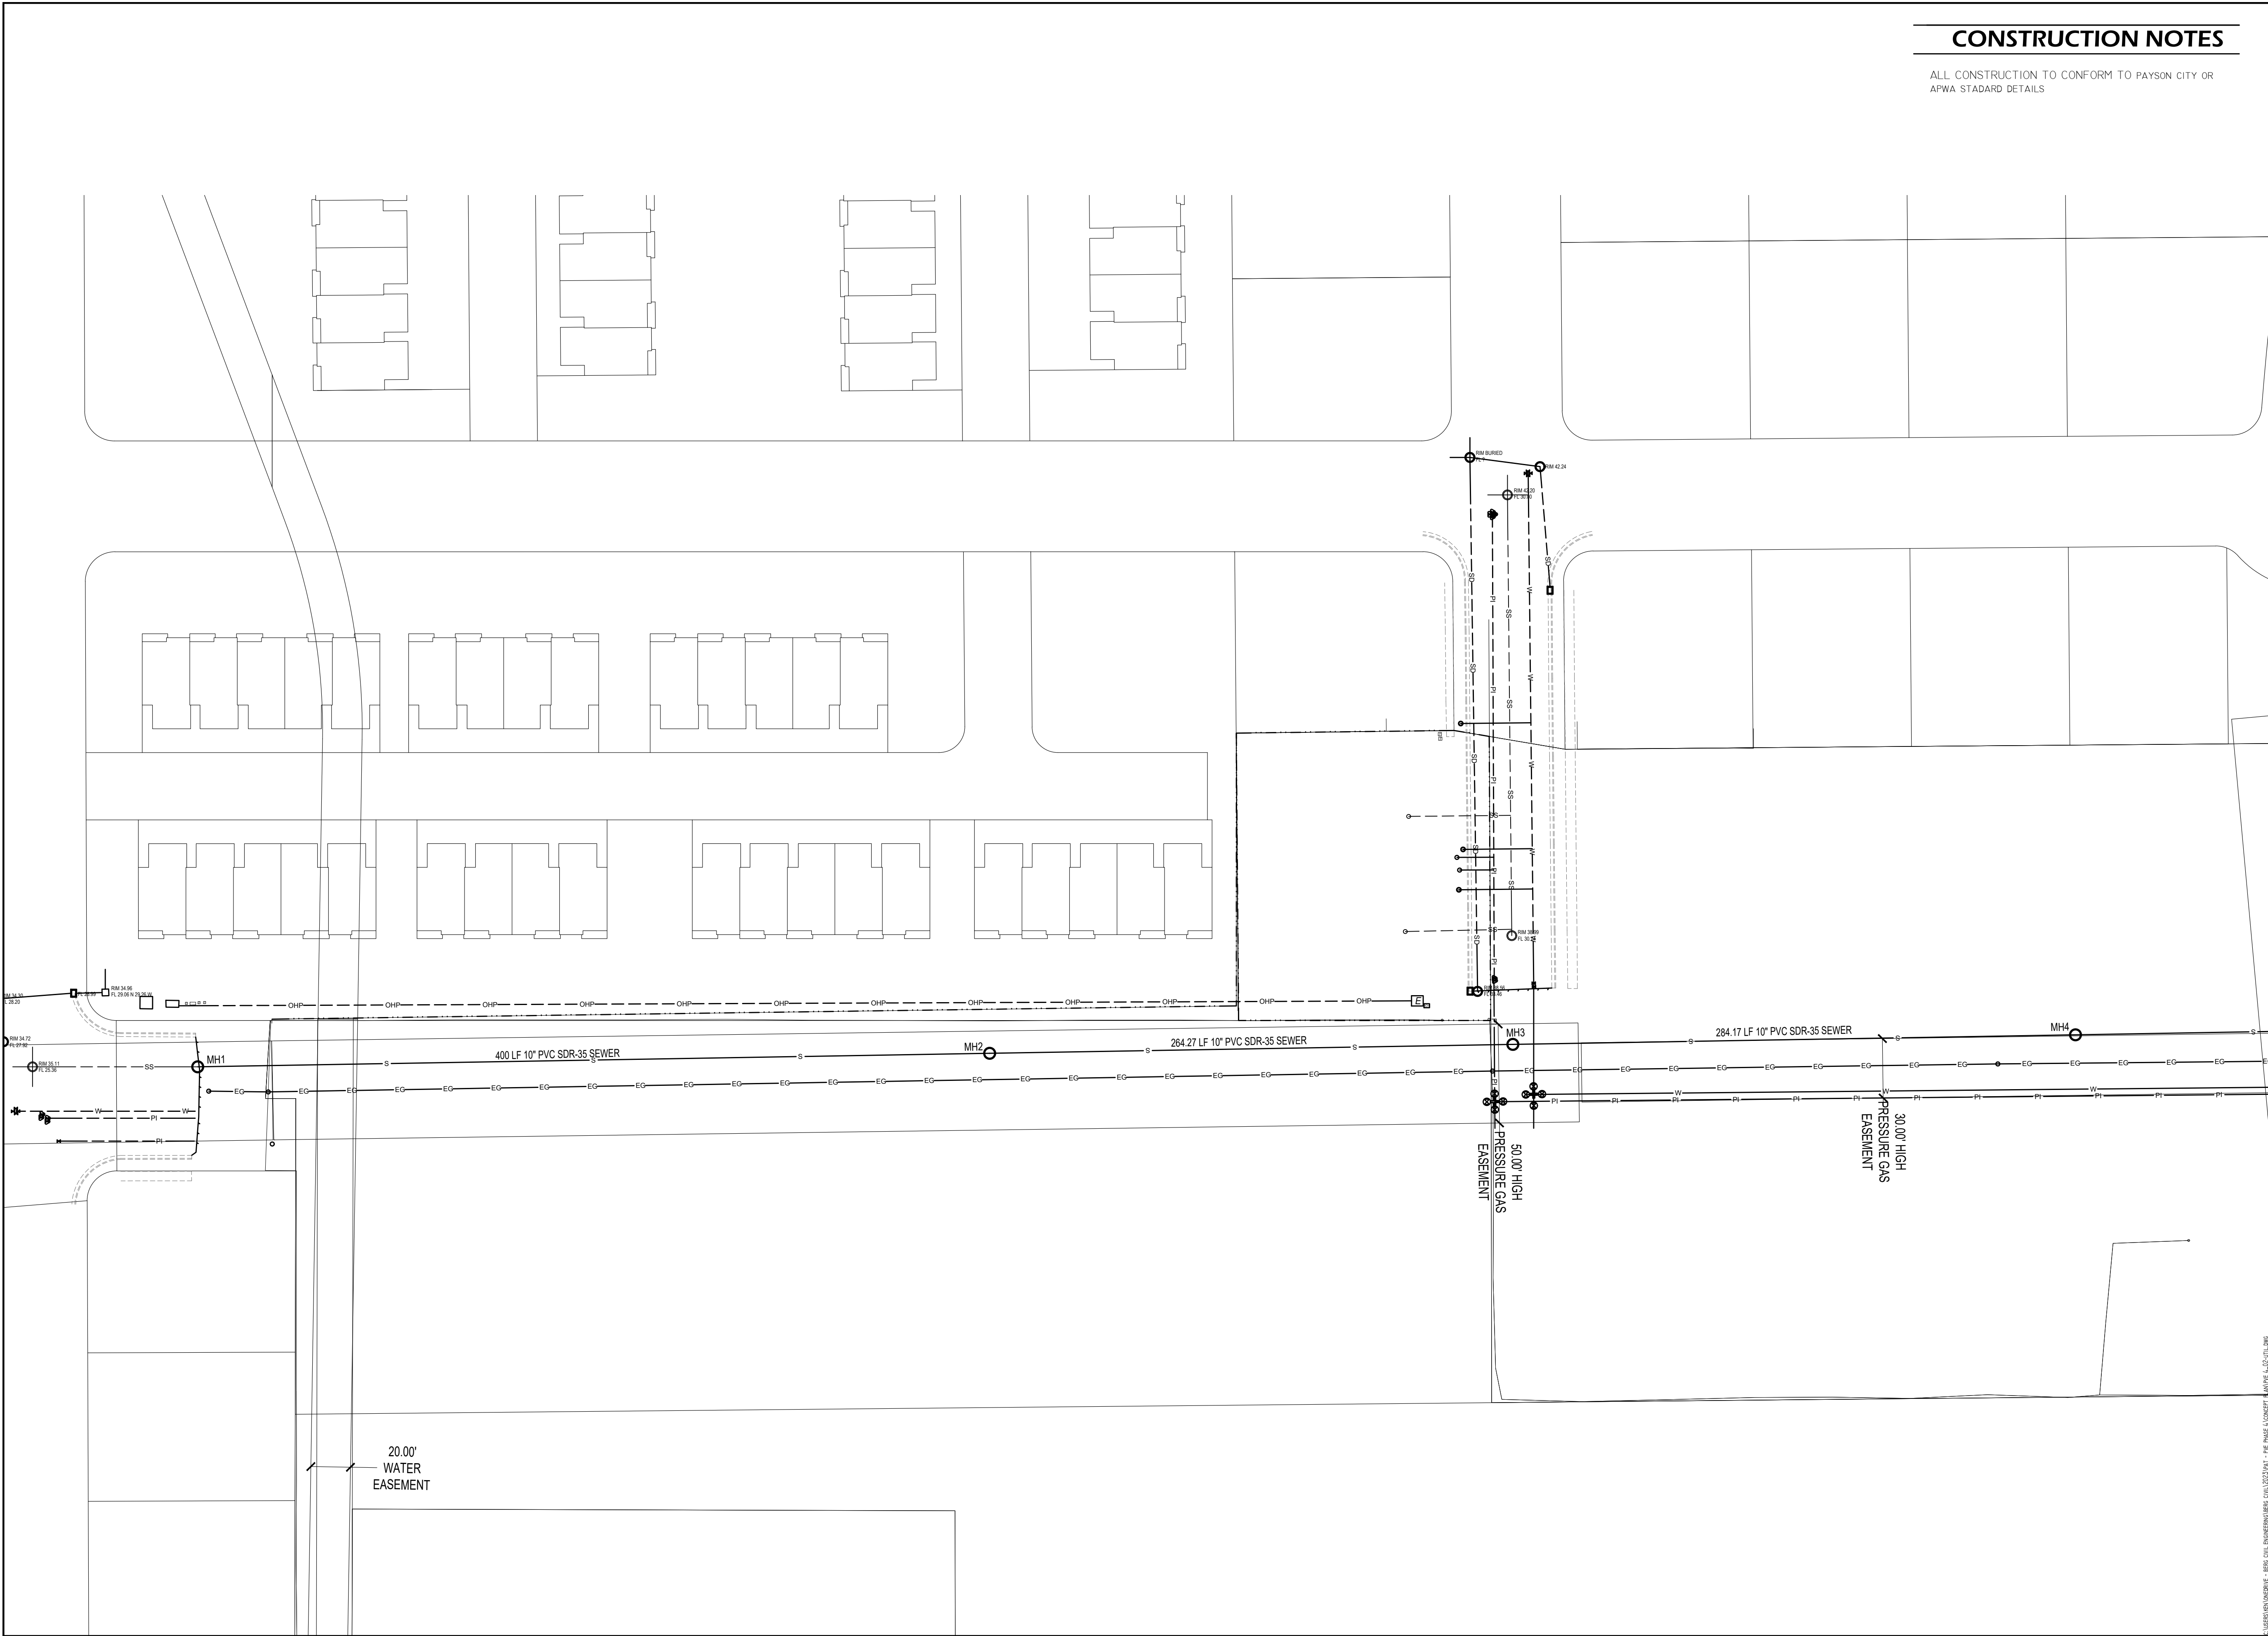

CONSTRUCTION NOTES

ALL CONSTRUCTION TO CONFORM TO PAYSON CITY OR
APWA STADARD DETAILS


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ACTION	DATE
PRELIM	01/16/2024

PROJECT

**PAYSON VIEW
ESTATES
PHASE 4**

DESCRIPTION

**PRELIMINARY
PLANS**

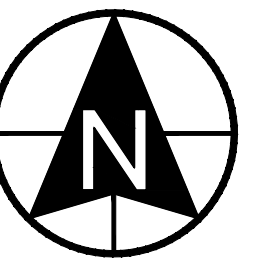SHEET NAME	SHEET NUMBER
SEWER	C2.3



CONSTRUCTION NOTES


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ACTION		DATE	
PRELIM		01/16/2024	

**PAYSON VIEW
ESTATES
PHASE 4**

**PRELIMINARY
PLANS**

SHEET NAME	SHEET NUMBER
POWER	C2.4

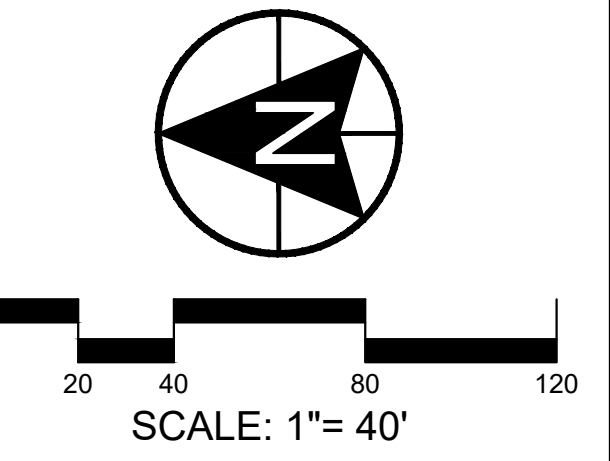

NO PARKING FIRE LANE

ALL CUL-DE-SAC'S ARE REQUIRED TO BE RED CURBED AND SIGNED "NO PARKING FIRE LANE"

CONSTRUCTION NOTES

NO TRAFFIC CALMING DEVICES TO BE INSTALLED
FIRE FLOW TO MEET CITY STANDARDS OF 2000 GPM


CODE ANALYSIS

ZONE =	R-I-9 & R-I-12
TYPE OF BUILDING =	SINGLE FAMILY
TYPE OF OCCUPANCY =	R-3
FIRE SPRINKLED =	NO
TYPE OF CONSTRUCTION =	V-B
BUILDING HEIGHT =	28

DEVELOPMENT


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


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ACTION			DATE
PRELIM			01/16/2024

PROJECT

**PAYSON VIEW
ESTATES
PHASE 4**

DESCRIPTION

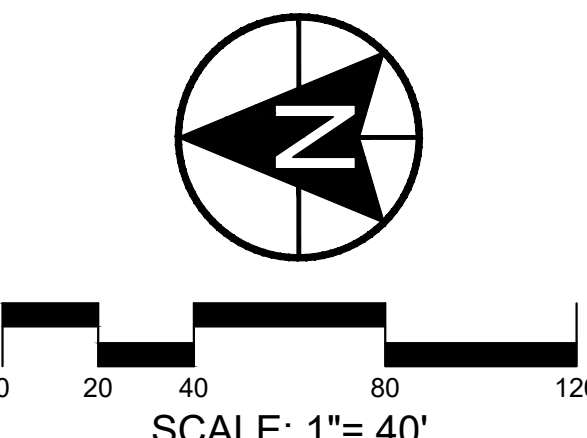**PRELIMINARY
PLANS**

SHEET NAME	SHEET NUMBER
FIRE	C2.5

RETENTION POND NOTES

1. RETENTION POND DESIGNED WITH THE CAPACITY TO CONTROL THE 100 YEAR-24 HOUR STORM EVENT
2. POND SIDE SLOPES OF 5:1
3. 1 FOOT FREEBOARD PROVIDED.
4. NO DISCHARGE INTO HIGH LINE CANAL IS ALLOWED.

LOT DRAINAGE

ALL LOTS TO CONTROL RUNOFF ON EACH LOT. NO LOT TO LOT DRAINAGE IS ALLOWED.

ALL LOTS REQUIRED TO HAVE FULL LANDSCAPE PRIOR TO OCCUPANCY.

CONSTRUCTION NOTES

ALL CONSTRUCTION TO CONFORM TO PAYSON CITY OR APWA STABARD DETAILS

A STORM WATER MANAGEMENT PLAN WILL BE REQUIRED PRIOR TO CONSTRUCTION

DRAINAGE CALCULATIONS

REFER TO SHEET C3.2 FOR STORM DRAINAGE CALCULATIONS FOR TEMPORARY POND

SURVEY CONTROL

SITE BENCHMARK
EAST QUARTER CORNER OF SEC. 20, T9S, R2E, SLB8M
B.M. ELEVATION = 4836.30

BASIS OF BEARING
N 89°35'10" E BETWEEN THE NORTHWEST AND NORTH QUARTER CORNERS OF SECTION 21, T9S, R2E, SLB8M


DEVELOPMENT

PAYSON VIEW ESTATES PHASE 4

DEVELOPER



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0 20 40 80 120
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ACTION	DATE
PRELIM	01/16/2024

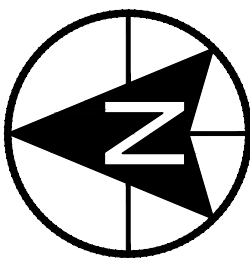PROJECT

PAYSON VIEW ESTATES PHASE 4


DESCRIPTION

PRELIMINARY PLANS

SHEET NAME

SHEET NUMBER

GRADE C3.1

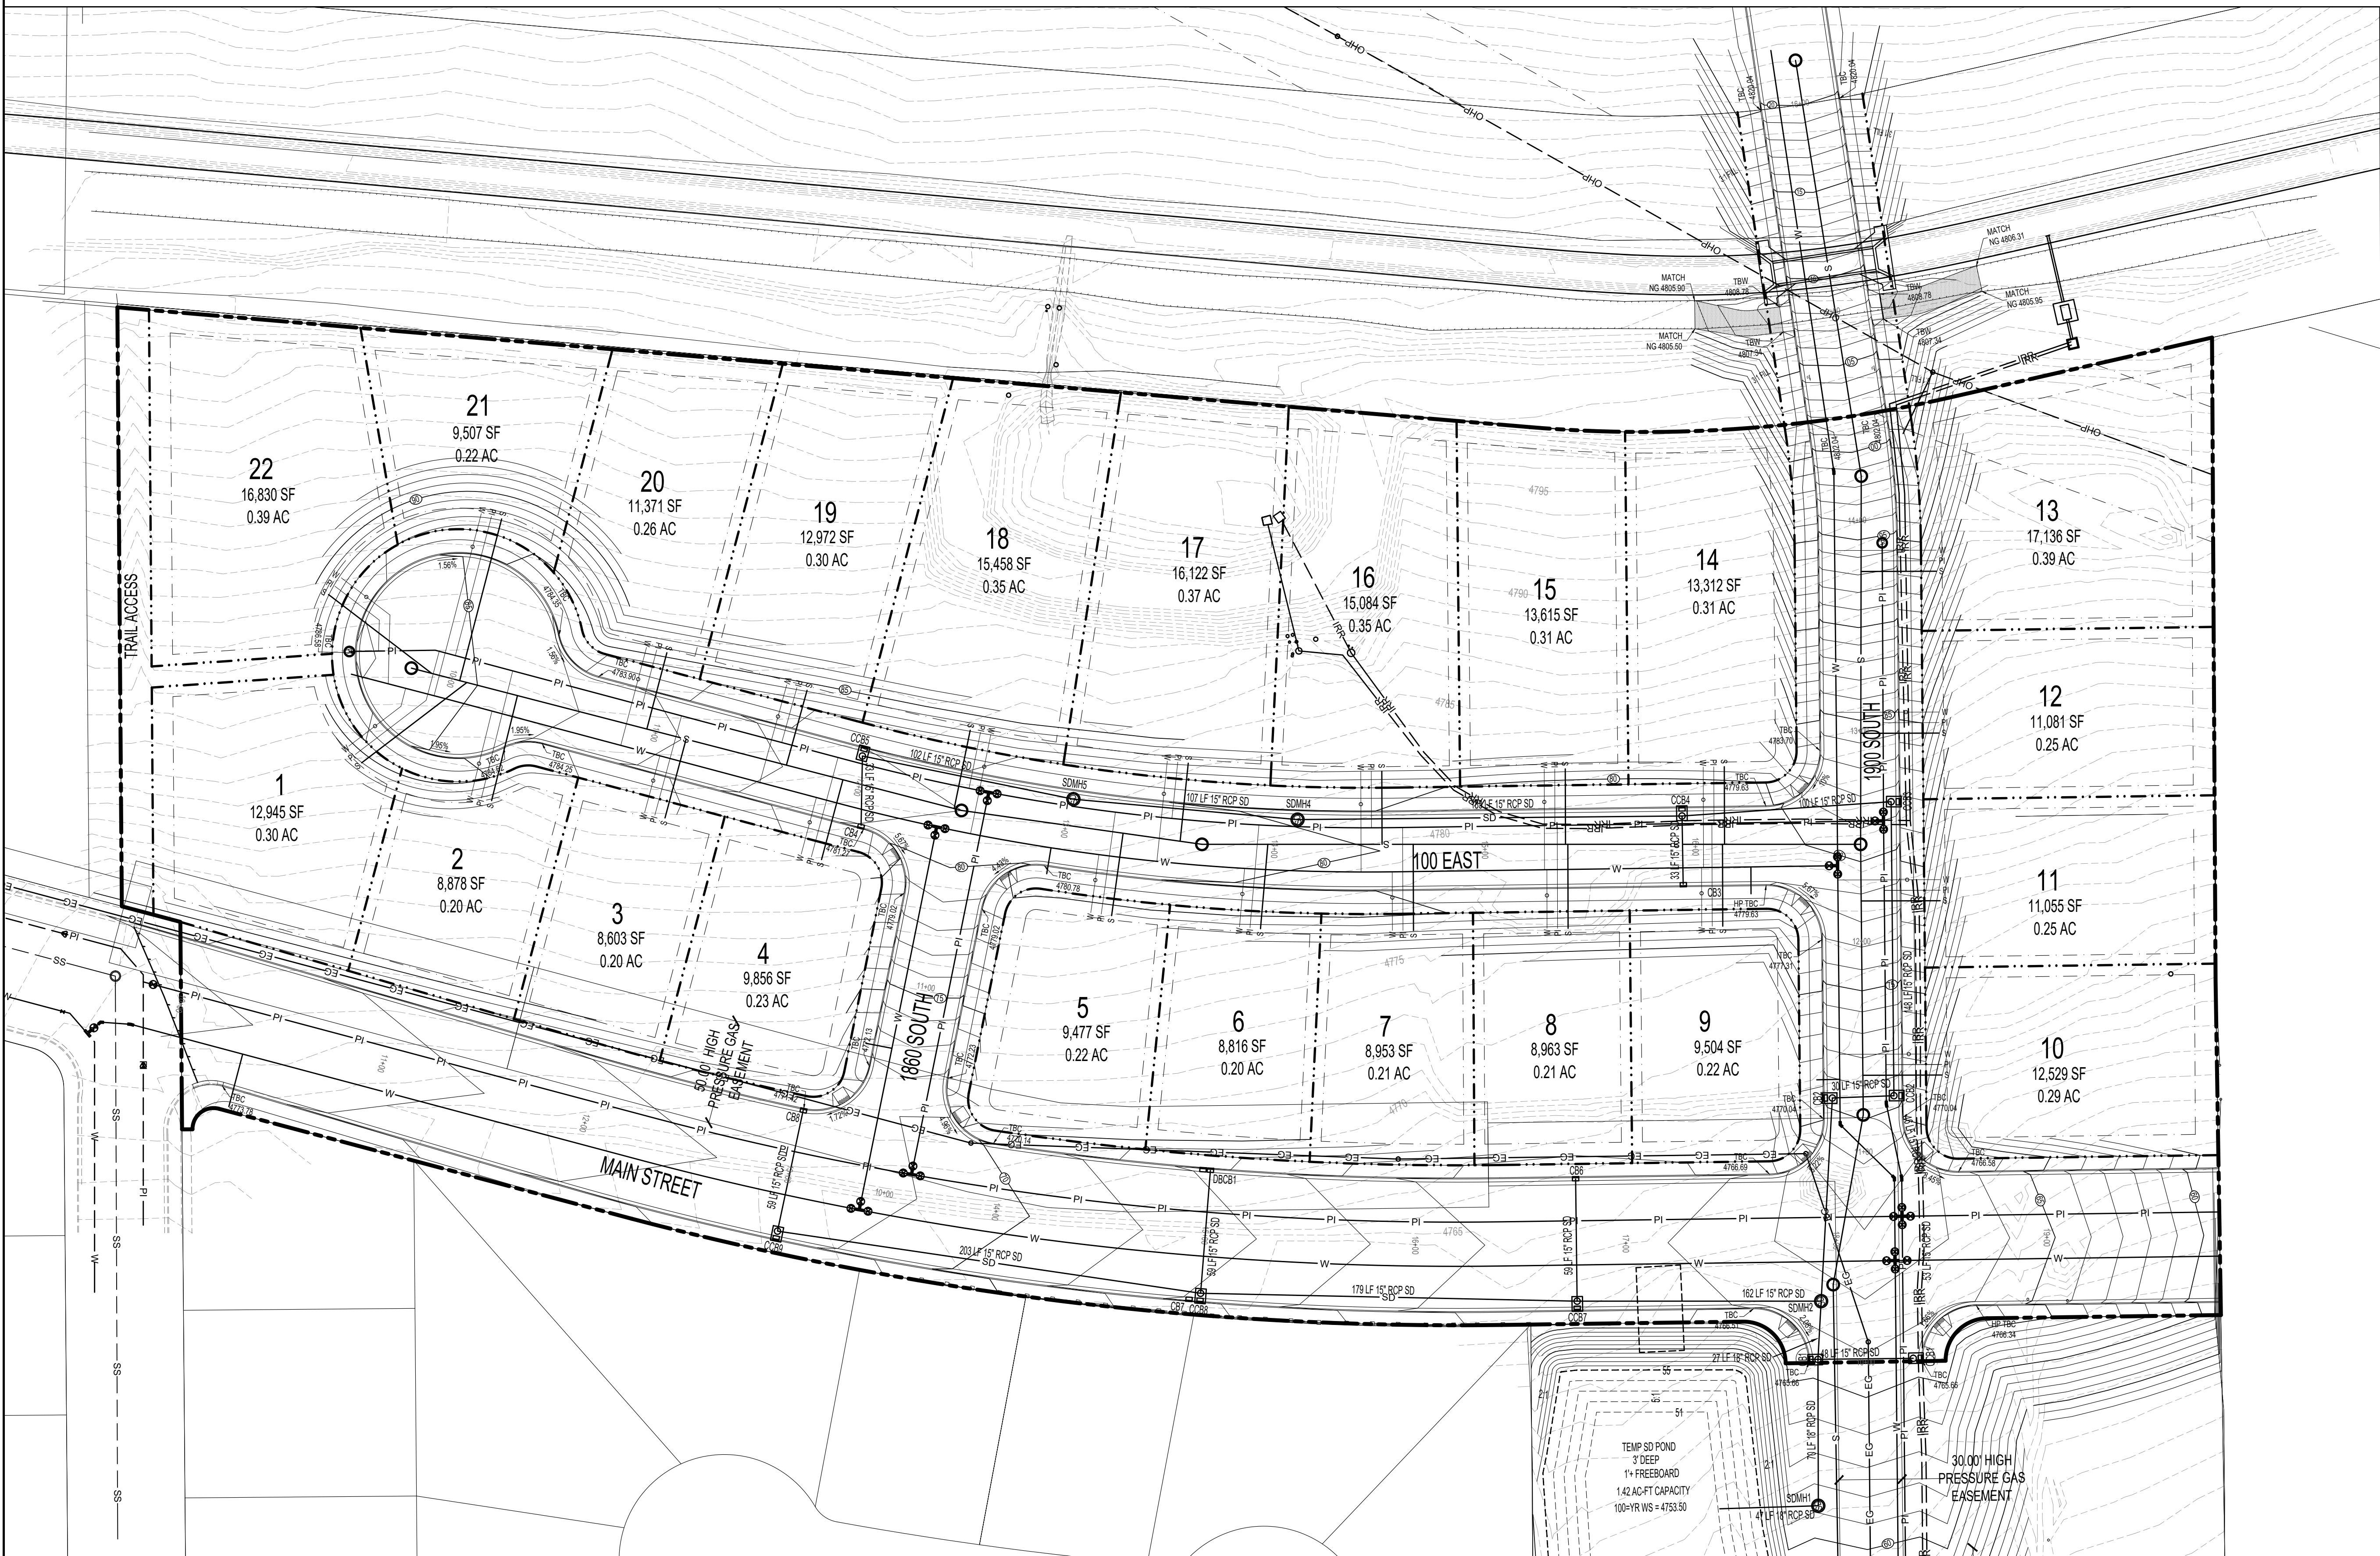

1. RETENTION POND DESIGNED WITH THE CAPACITY TO CONTROL THE 100 YEAR-24 HOUR STORM EVENT
2. POND SIDE SLOPES OF 5:1
3. 1 FOOT FREEBOARD PROVIDED.
4. NO DISCHARGE INTO HIGH LINE CANAL IS ALLOWED.

ALL LOTS TO CONTROL RUNOFF ON EACH LOT. NO LOT TO LOT DRAINAGE IS ALLOWED.

ALL LOTS REQUIRED TO HAVE FULL LANDSCAPE PRIOR TO OCCUPANCY.


ALL CONSTRUCTION TO CONFORM TO
PAYSON CITY OR APWA STADARD DETAILS

A STORM WATER MANAGEMENT PLAN
WILL BE REQUIRED PRIOR TO
CONSTRUCTION

REFER TO SHEET C3.2 FOR STORM
DRAINAGE CALCULATIONS FOR
TEMPORARY POND

SITE BENCHMARK
EAST QUARTER CORNER OF SEC 20,T9S, R2E, SLB&M
B.M. ELEVATION = 4836.30

BASIS OF BEARING
N 89°35'10" E BETWEEN THE NORTHWEST AND
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SLB8M

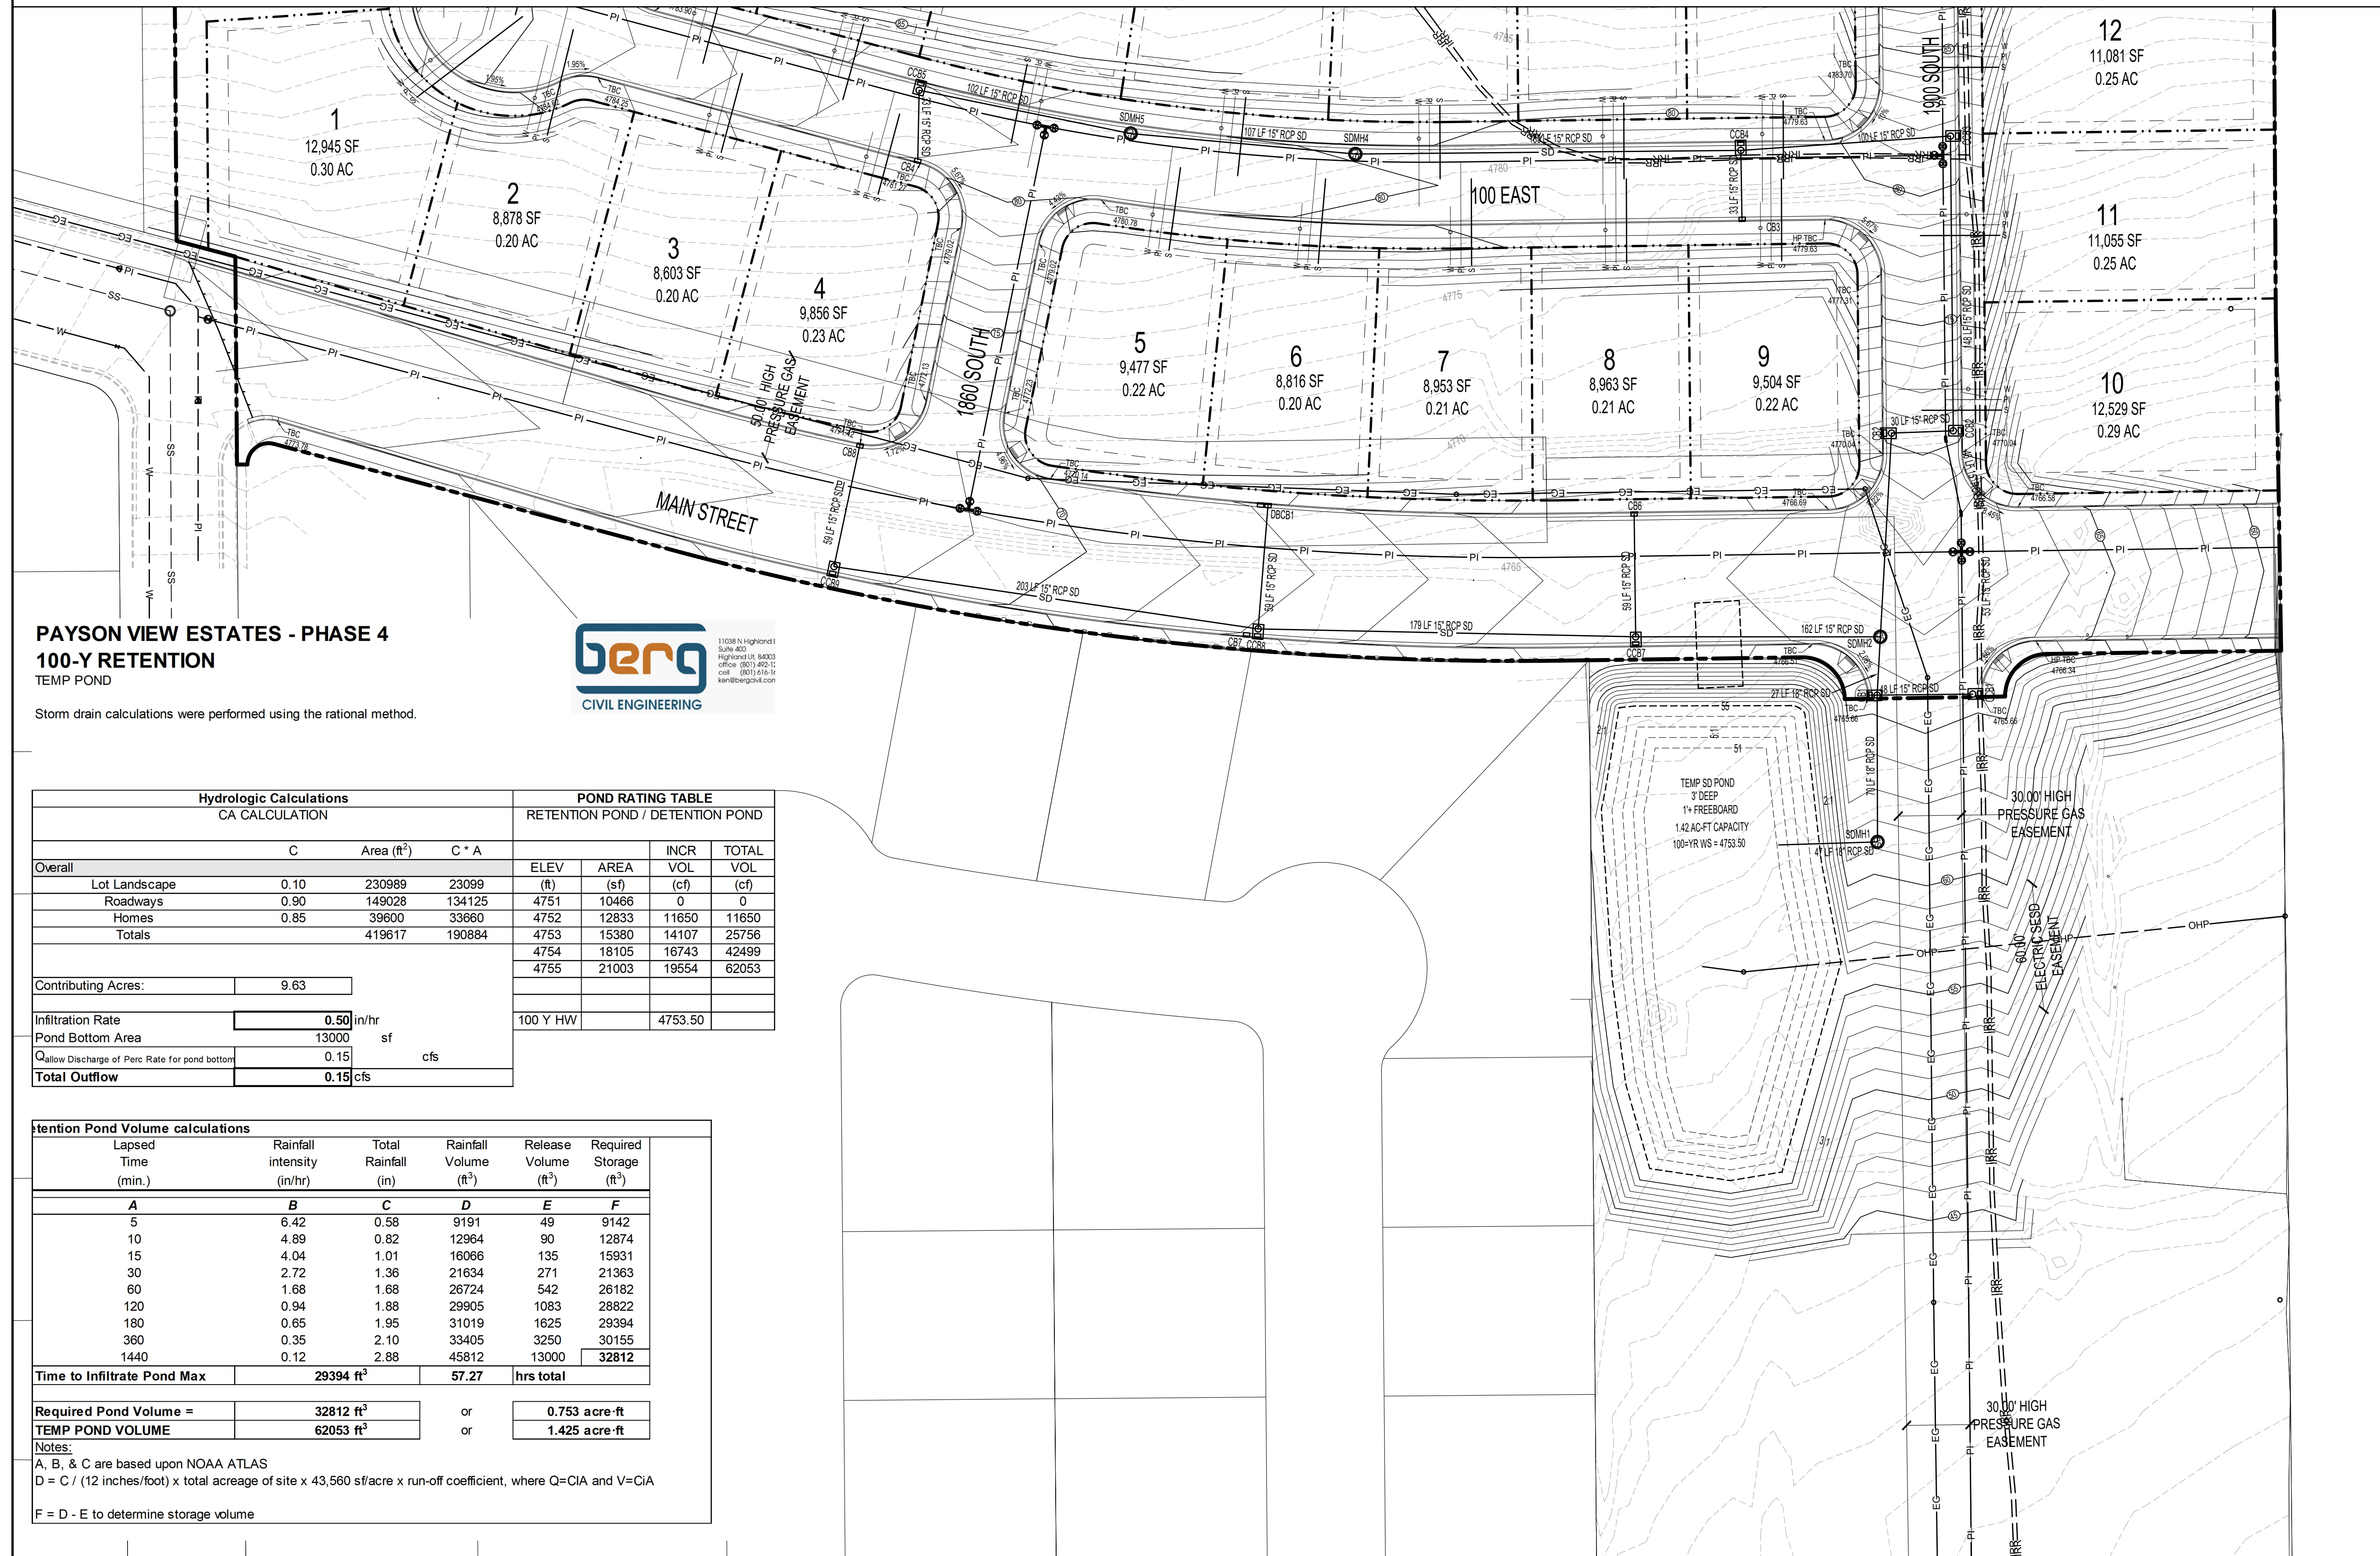


DEVELOPMENT

*PAYSON
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PHASE 4*

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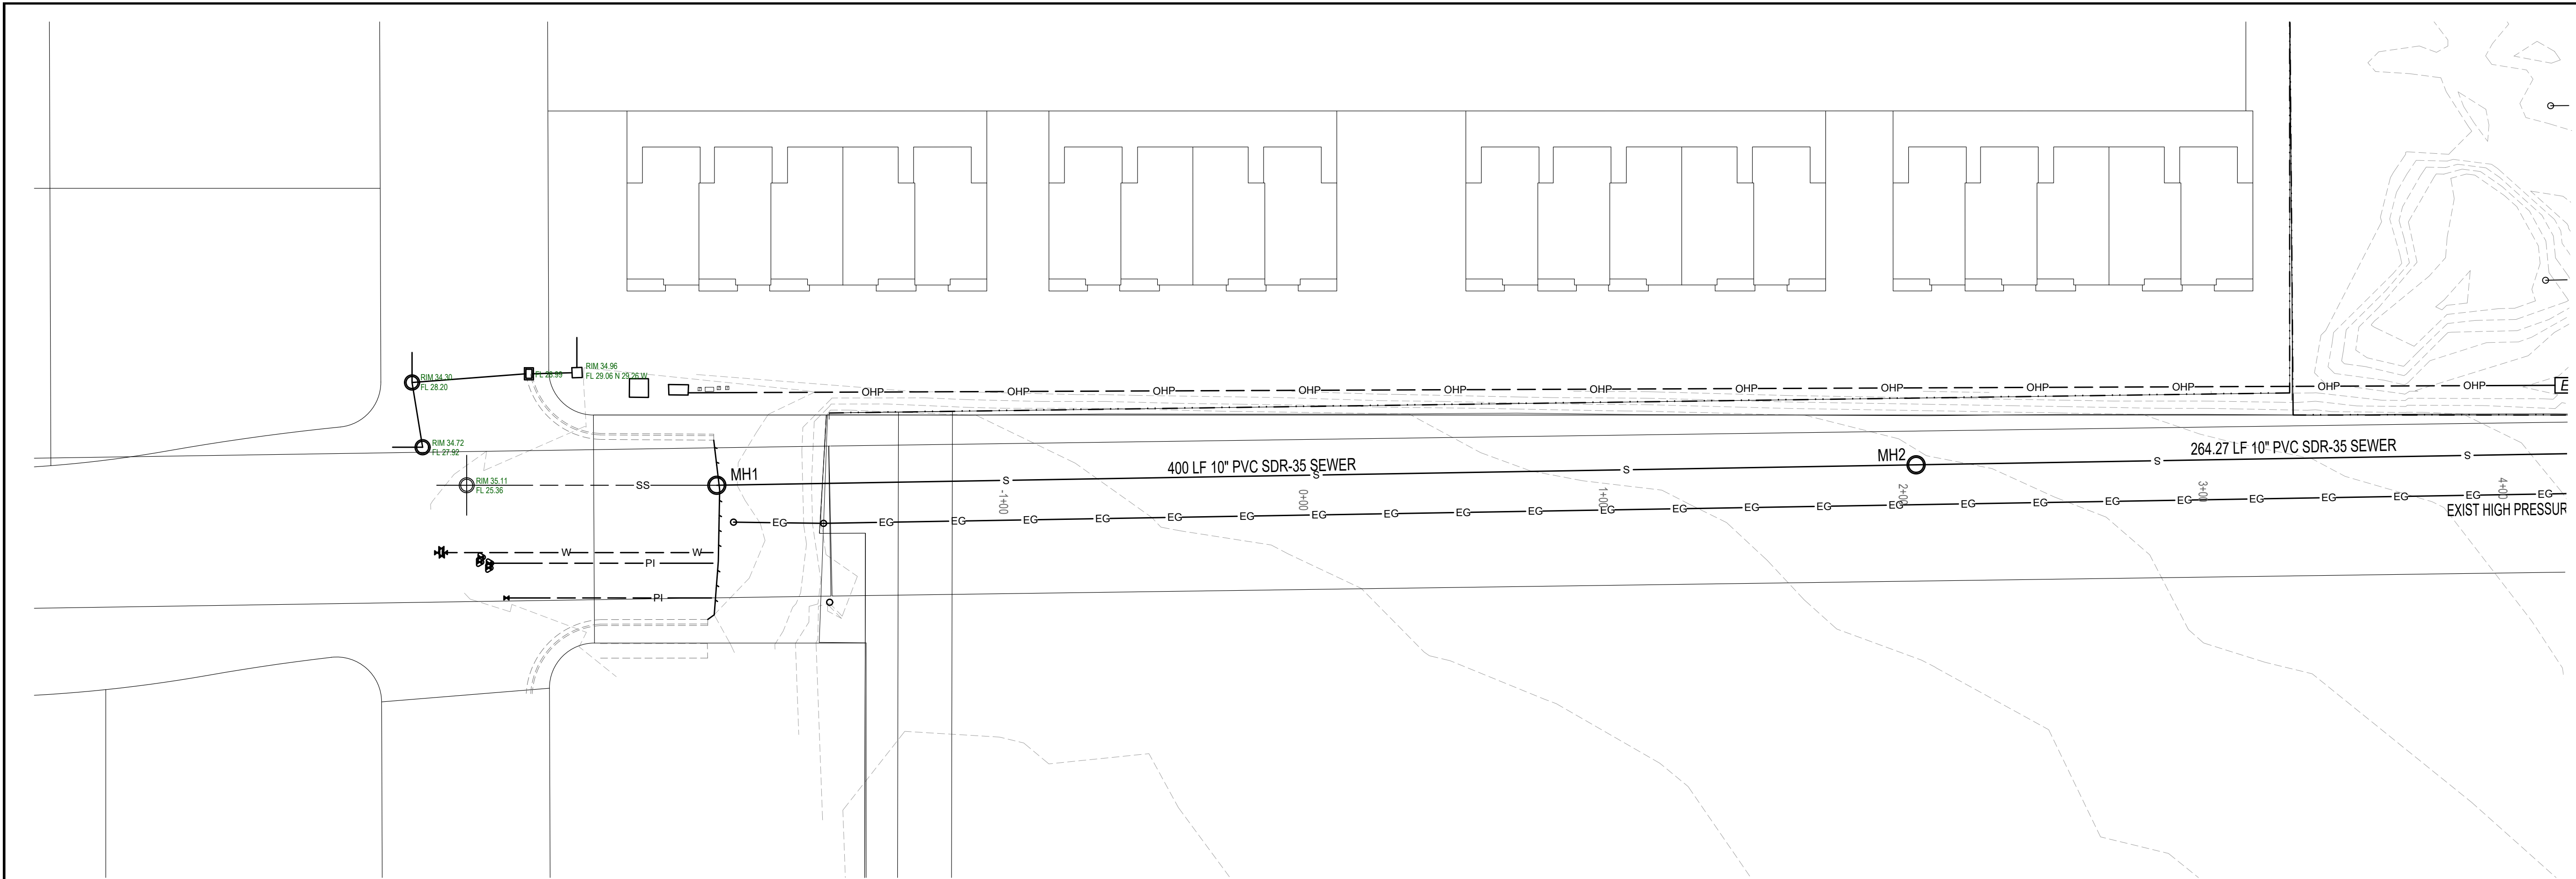
PROJECT

*PAYSON VIEW
ESTATES
PHASE 4*

DESCRIPTION
1. The first step in the process of creating a new product is to identify a market need. This involves conducting market research to determine what consumers want and need. Once a market need is identified, the next step is to develop a concept for a product that meets that need.
2. The second step in the process is to develop a business plan. This involves determining the costs of production, the pricing strategy, and the marketing strategy. The business plan also includes a financial forecast and a break-even analysis.
3. The third step in the process is to secure financing. This involves obtaining the funds needed to develop and produce the product. There are several ways to secure financing, including bank loans, venture capital, and crowdfunding.
4. The fourth step in the process is to develop a prototype. This involves creating a small-scale version of the product to test the design and functionality. The prototype is used to gather feedback from potential customers and to make any necessary adjustments to the design.
5. The fifth step in the process is to produce the product. This involves manufacturing the product on a large scale. There are several ways to produce a product, including in-house production, contract manufacturing, and dropshipping.
6. The sixth step in the process is to market the product. This involves promoting the product to potential customers through various marketing channels, including social media, email marketing, and direct sales. The goal is to create awareness of the product and generate sales.
7. The seventh step in the process is to distribute the product. This involves getting the product into the hands of customers. There are several ways to distribute a product, including through retail stores, online marketplaces, and direct sales.
8. The eighth step in the process is to provide customer support. This involves helping customers with any issues they may have with the product. Customer support can be provided through various channels, including phone, email, and chat.

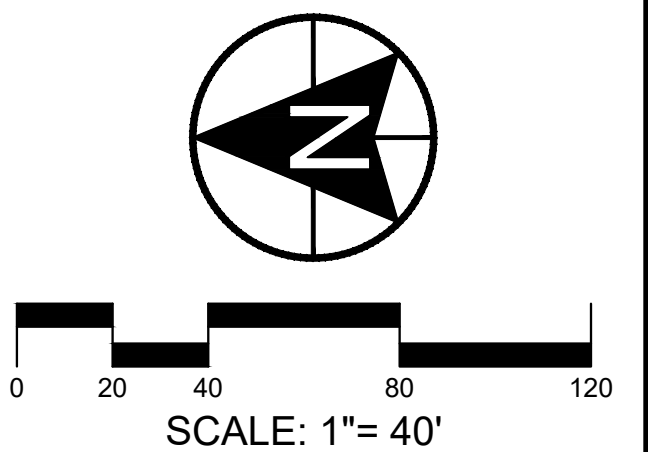PRELIMINARY PLANS

SHEET NAME	SHEET NUMBER
GRADE	C3.2



CONSTRUCTION NOTES

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PAYSON CITY OR APWA STADARD DETAILS

A STORM WATER MANAGEMENT PLAN
WILL BE REQUIRED PRIOR TO
CONSTRUCTION


DRAINAGE CALCULATIONS

REFER TO SHEET C3.2 FOR STORM
DRAINAGE CALCULATIONS FOR
TEMPORARY POND

SURVEY CONTROL

SITE BENCHMARK
EAST QUARTER CORNER OF SEC. 20,T9S, R2E, SLB8M
B.M. ELEVATION = 4836.30

BASIS OF BEARING
N 89°35'10" E BETWEEN THE NORTHWEST AND
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SLB8M

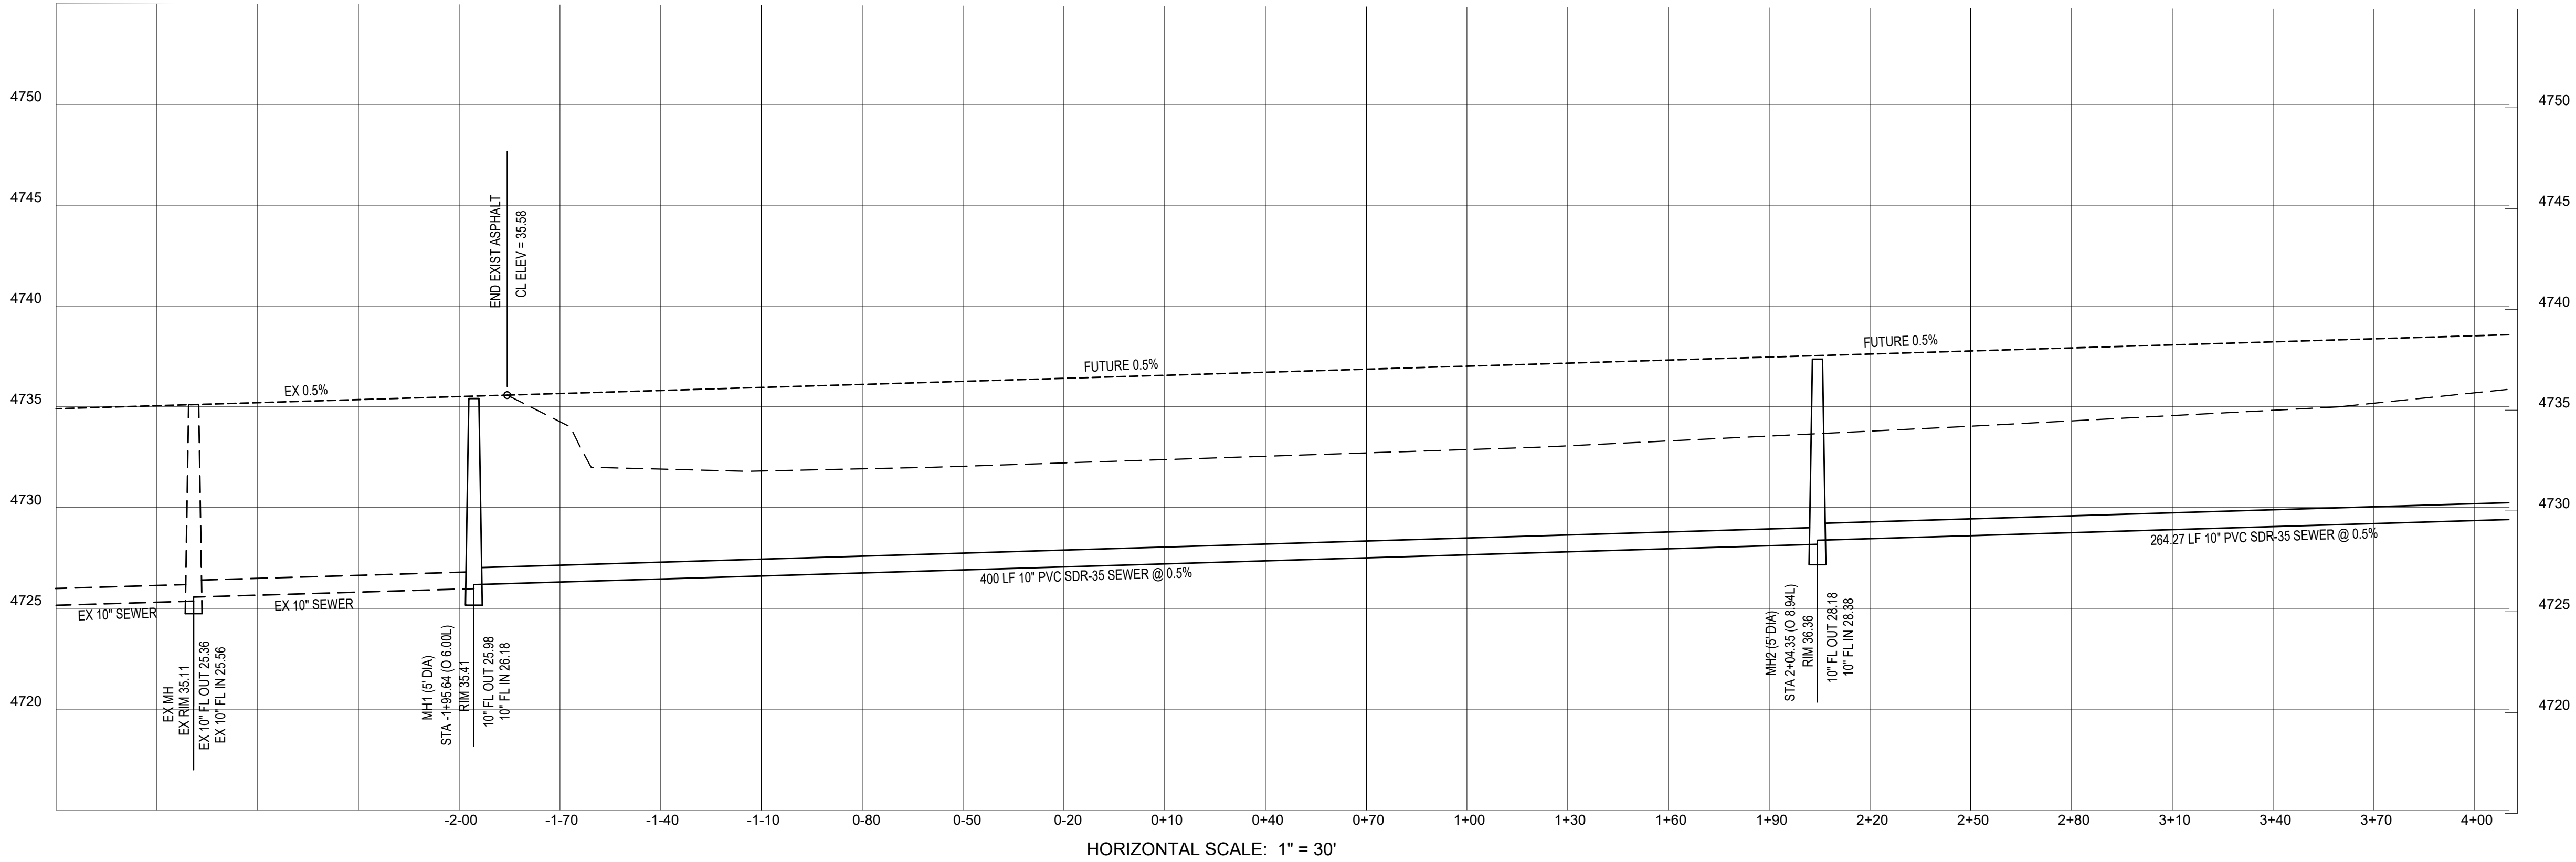


DEVELOPMENT

PAYSON
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0 15 30 60 90
SCALE: 1"= 30'



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PRELIM	01/16/2024

PROJECT


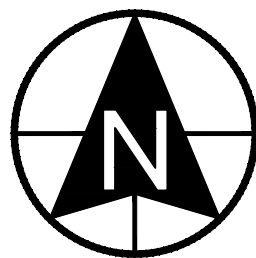
PAYSON VIEW
ESTATES
PHASE 4

DESCRIPTION

PRELIMINARY
PLANS

SHEET NAME SHEET NUMBER

1900 S C4.1

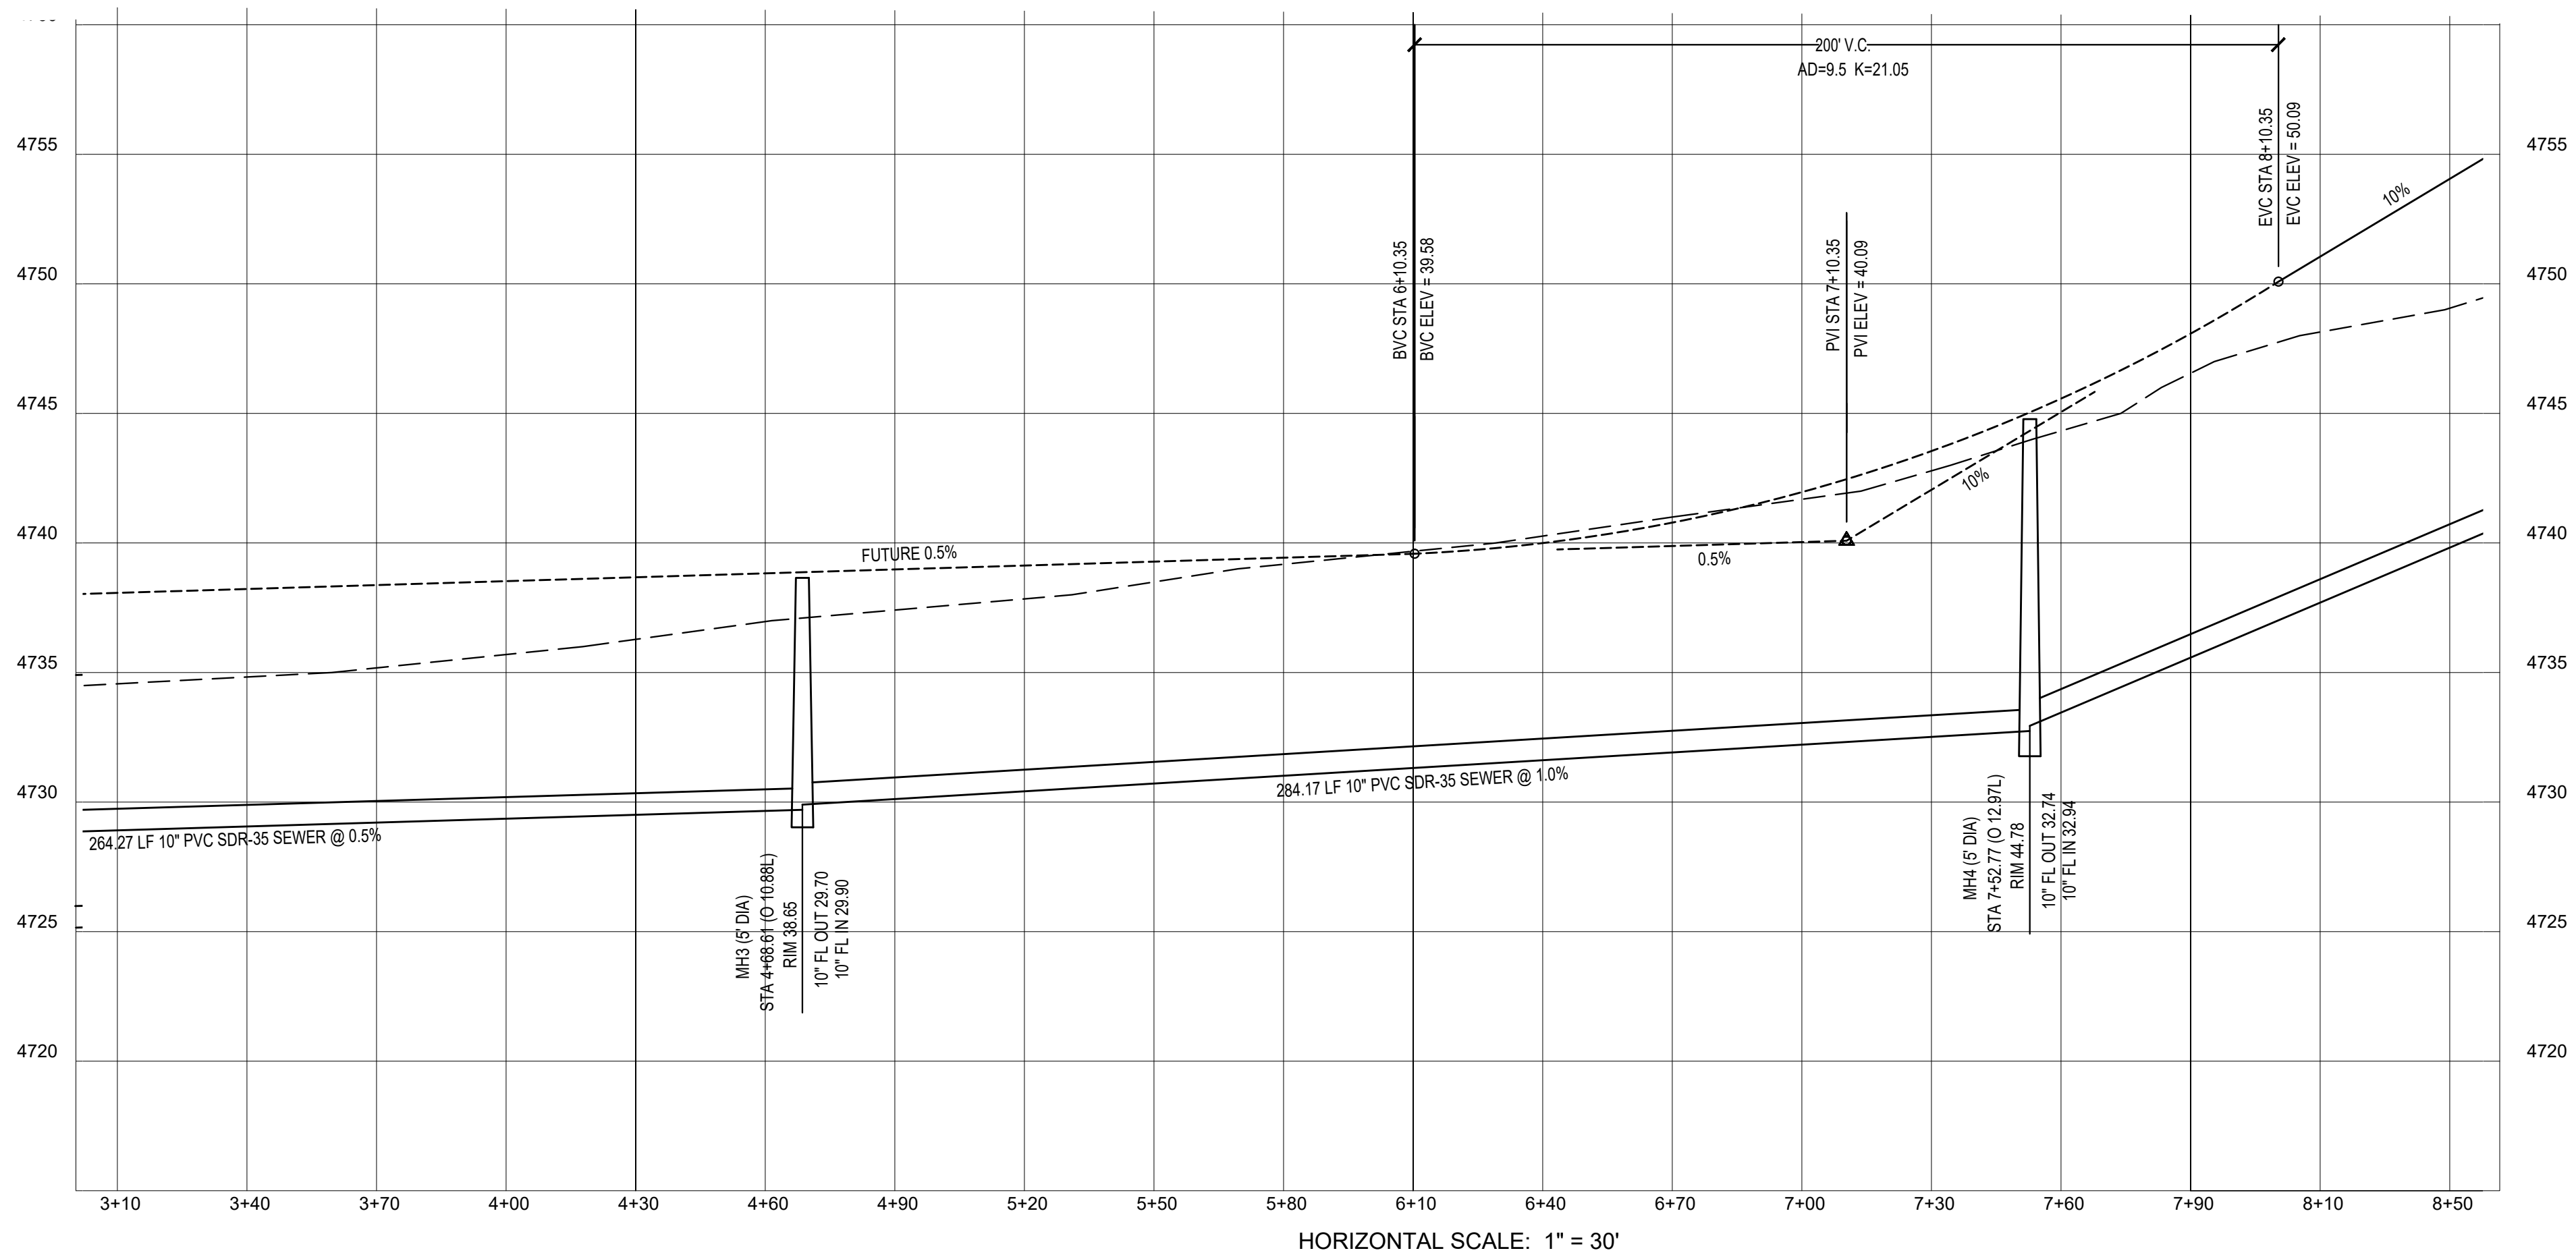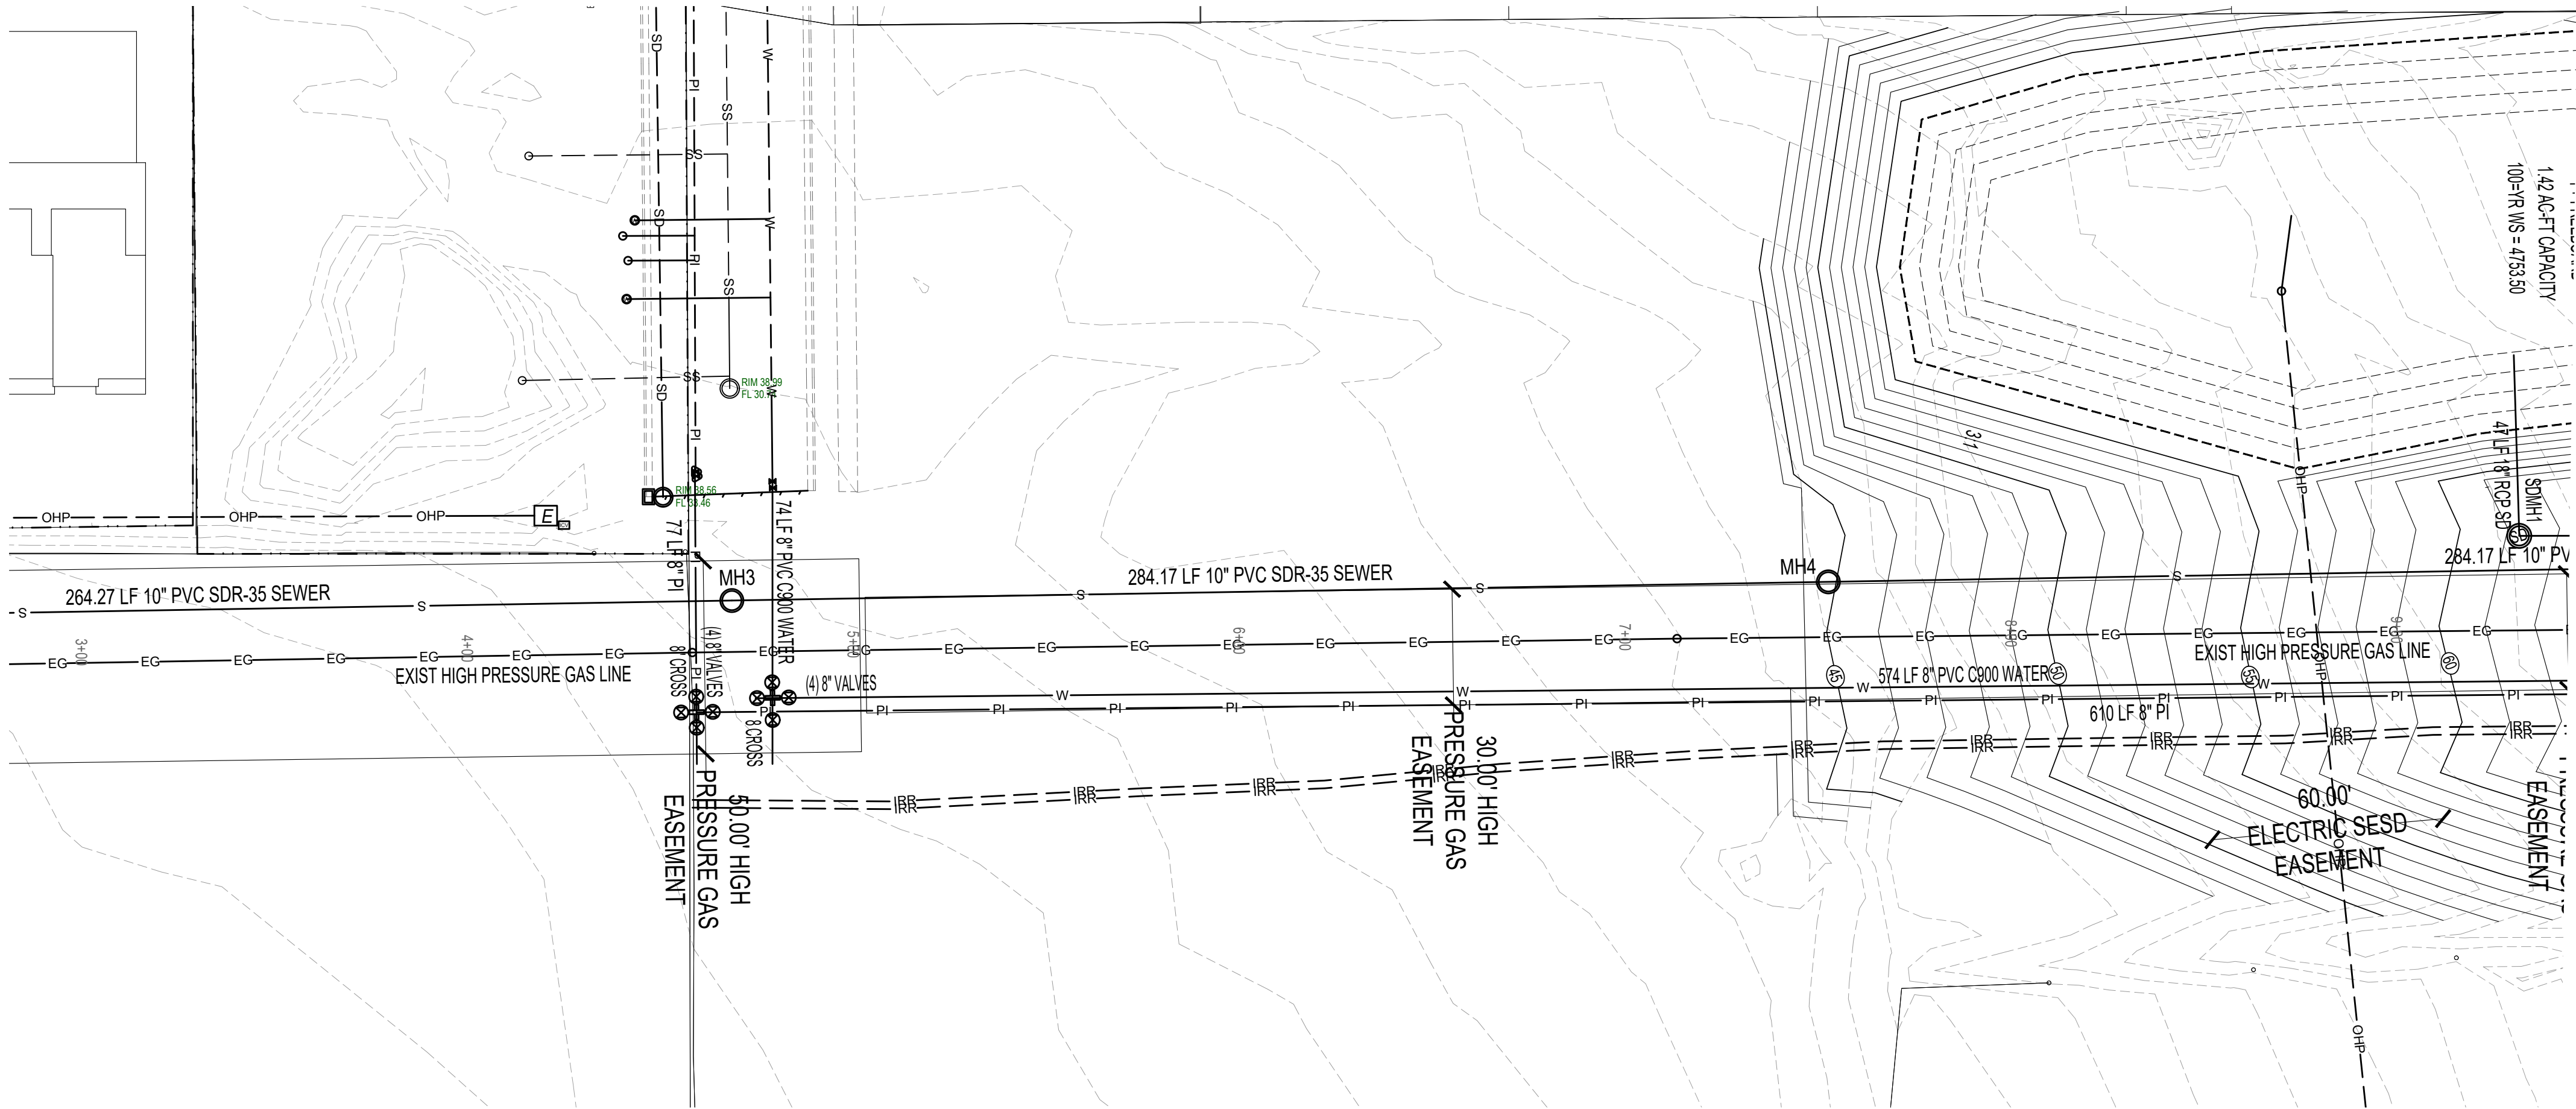

CONSTRUCTION NOTES

ALL CONSTRUCTION TO CONFORM TO
PAYSON CITY OR APWA STADARD DETAILS

A STORM WATER MANAGEMENT PLAN
WILL BE REQUIRED PRIOR TO
CONSTRUCTION

DRAINAGE CALCULATIONS

REFER TO SHEET C3.2 FOR STORM
DRAINAGE CALCULATIONS FOR
TEMPORARY POND

SURVEY CONTROL

SITE BENCHMARK
EAST QUARTER CORNER OF SEC 20,T9S, R2E, SLB8M
B.M. ELEVATION = 4836.30

BASIS OF BEARING
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SLB8M


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0 15 30 60 90
SCALE: 1"= 30'



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PRELIM	01/16/2024

PROJECT


PAYSON VIEW ESTATES PHASE 4

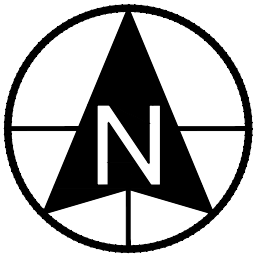DESCRIPTION

PRELIMINARY PLANS

SHEET NAME SHEET NUMBER

1900 S C4.2

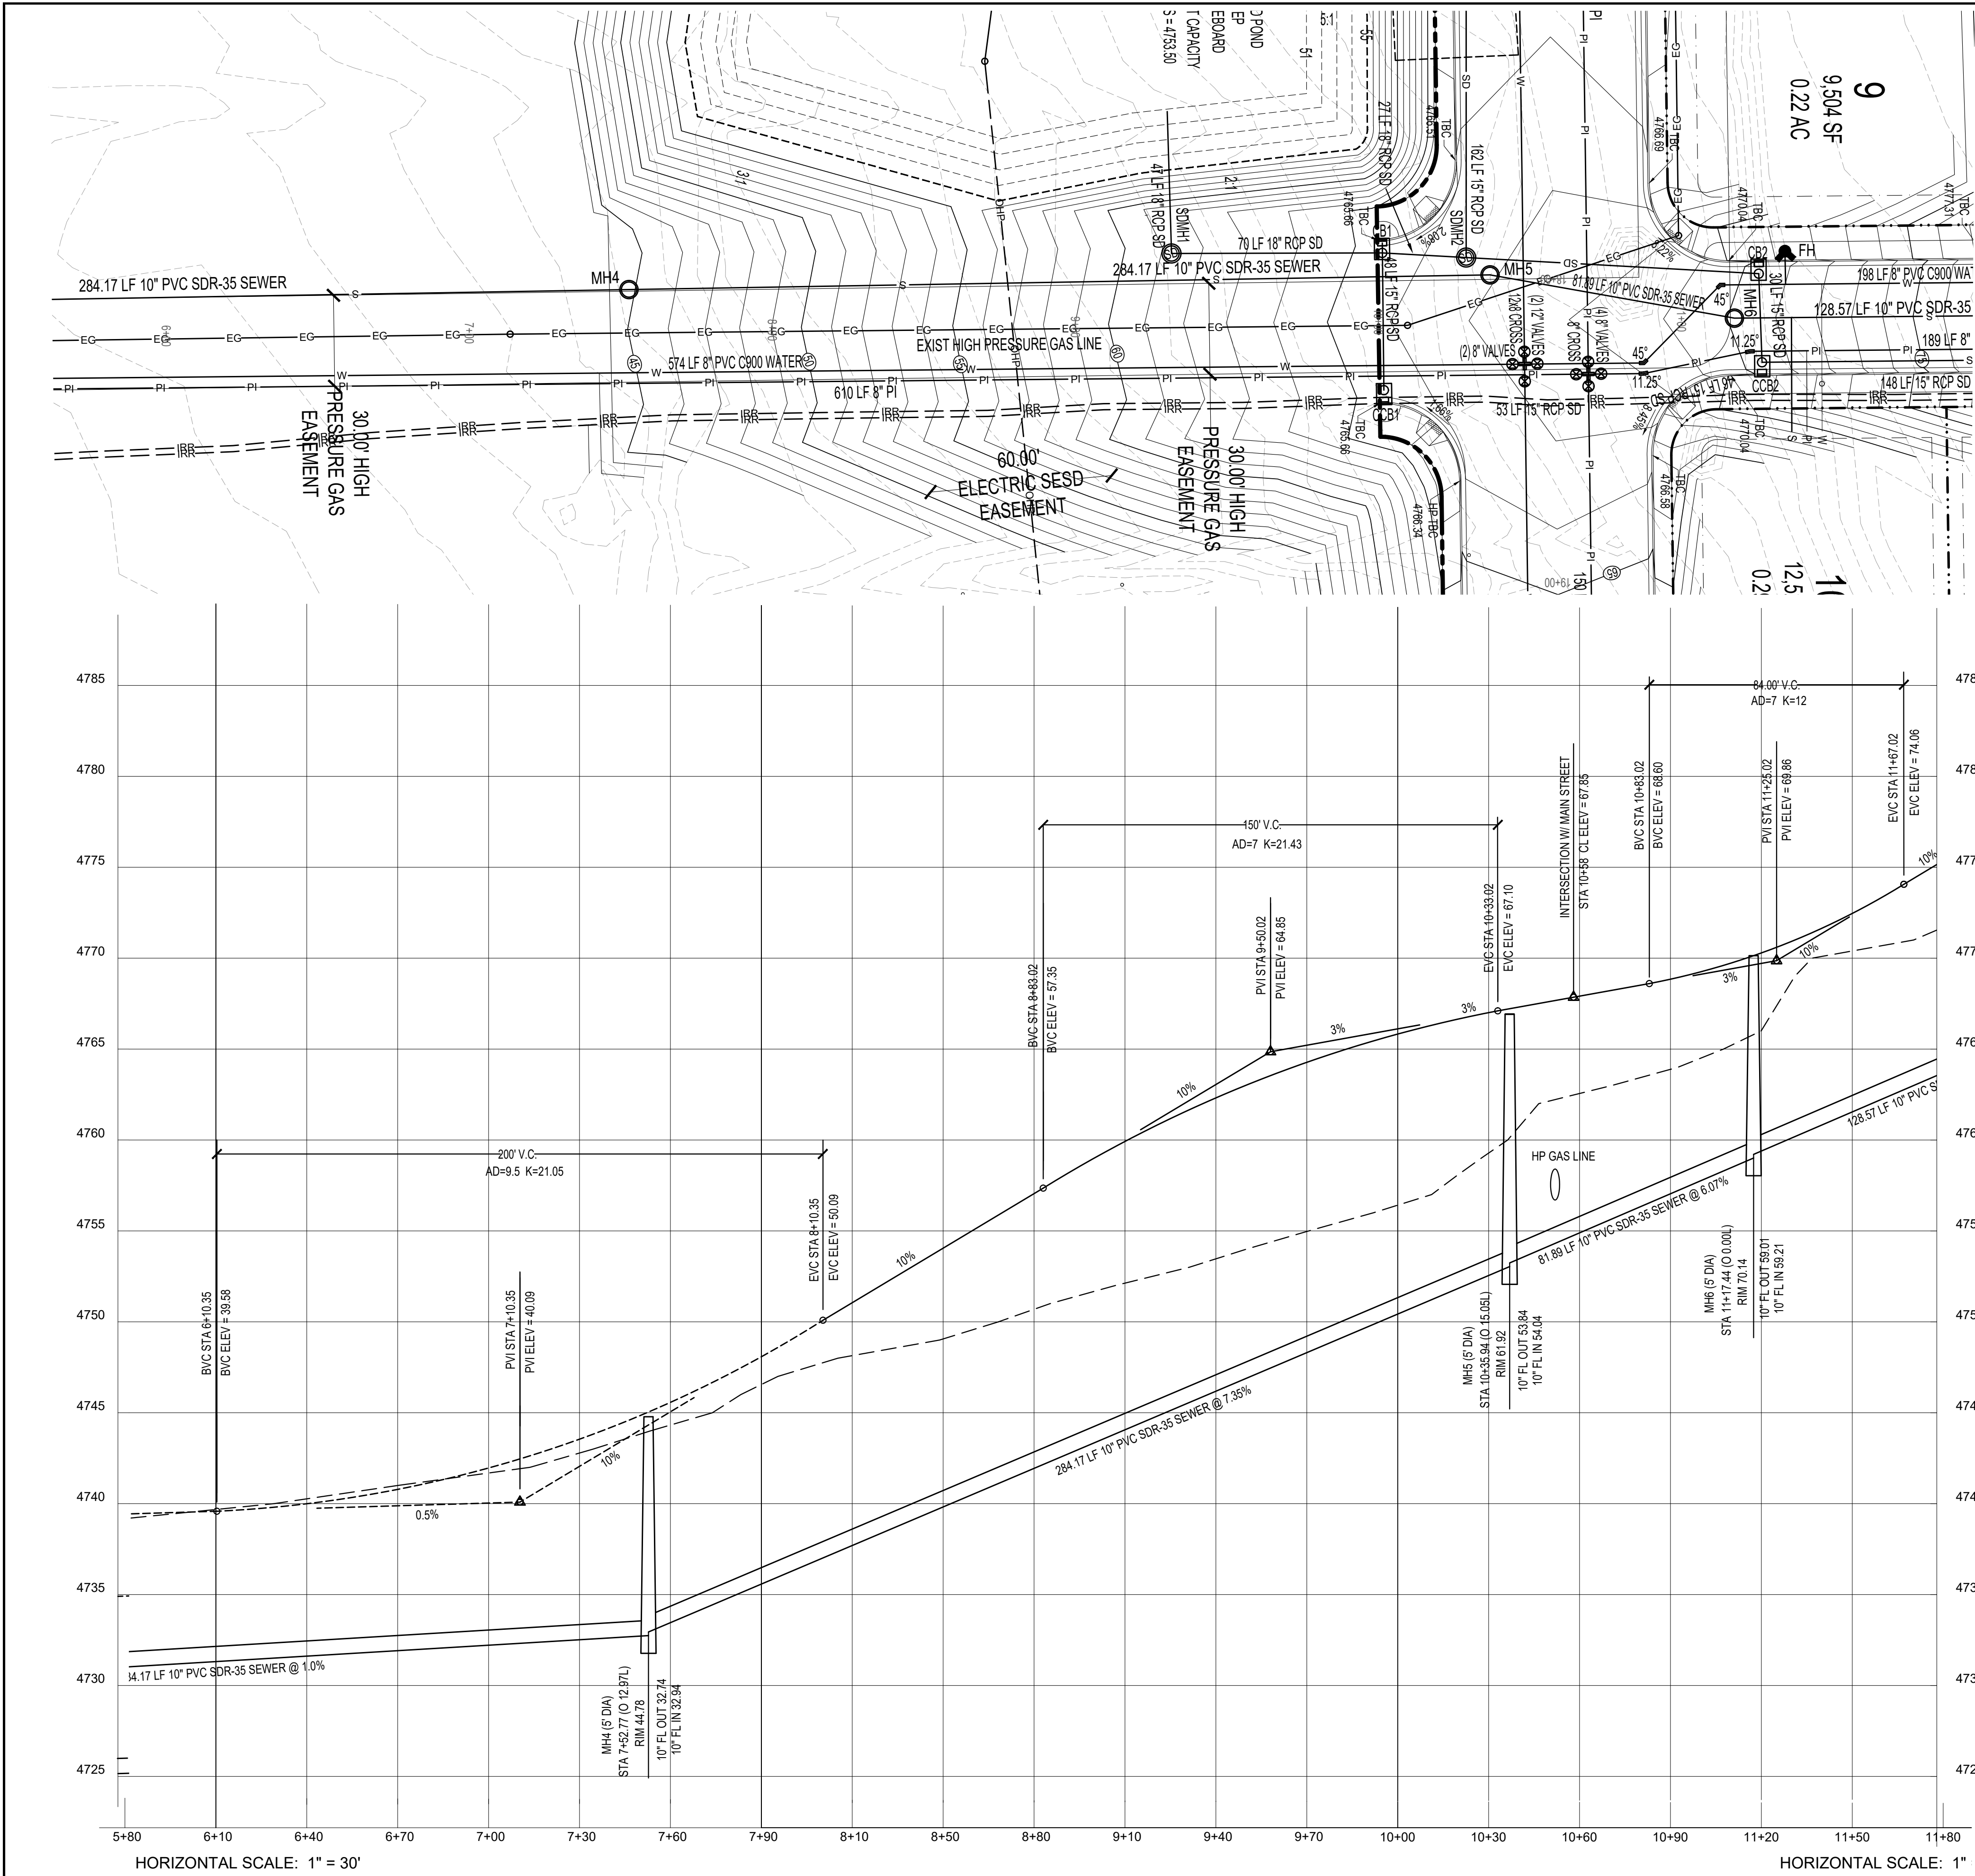

CONSTRUCTION NOTES

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WILL BE REQUIRED PRIOR TO
CONSTRUCTION

DRAINAGE CALCULATIONS

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DRAINAGE CALCULATIONS FOR
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SURVEY CONTROL

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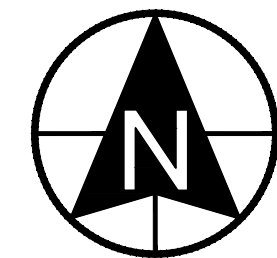
DEVELOPMENT

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DEVELOPER




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PROJECT


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DESCRIPTION

PRELIMINARY PLANS

SHEET NAME SHEET NUMBER

1900 S C4.3

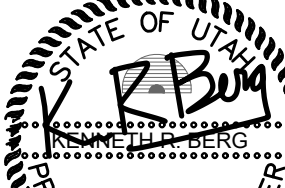

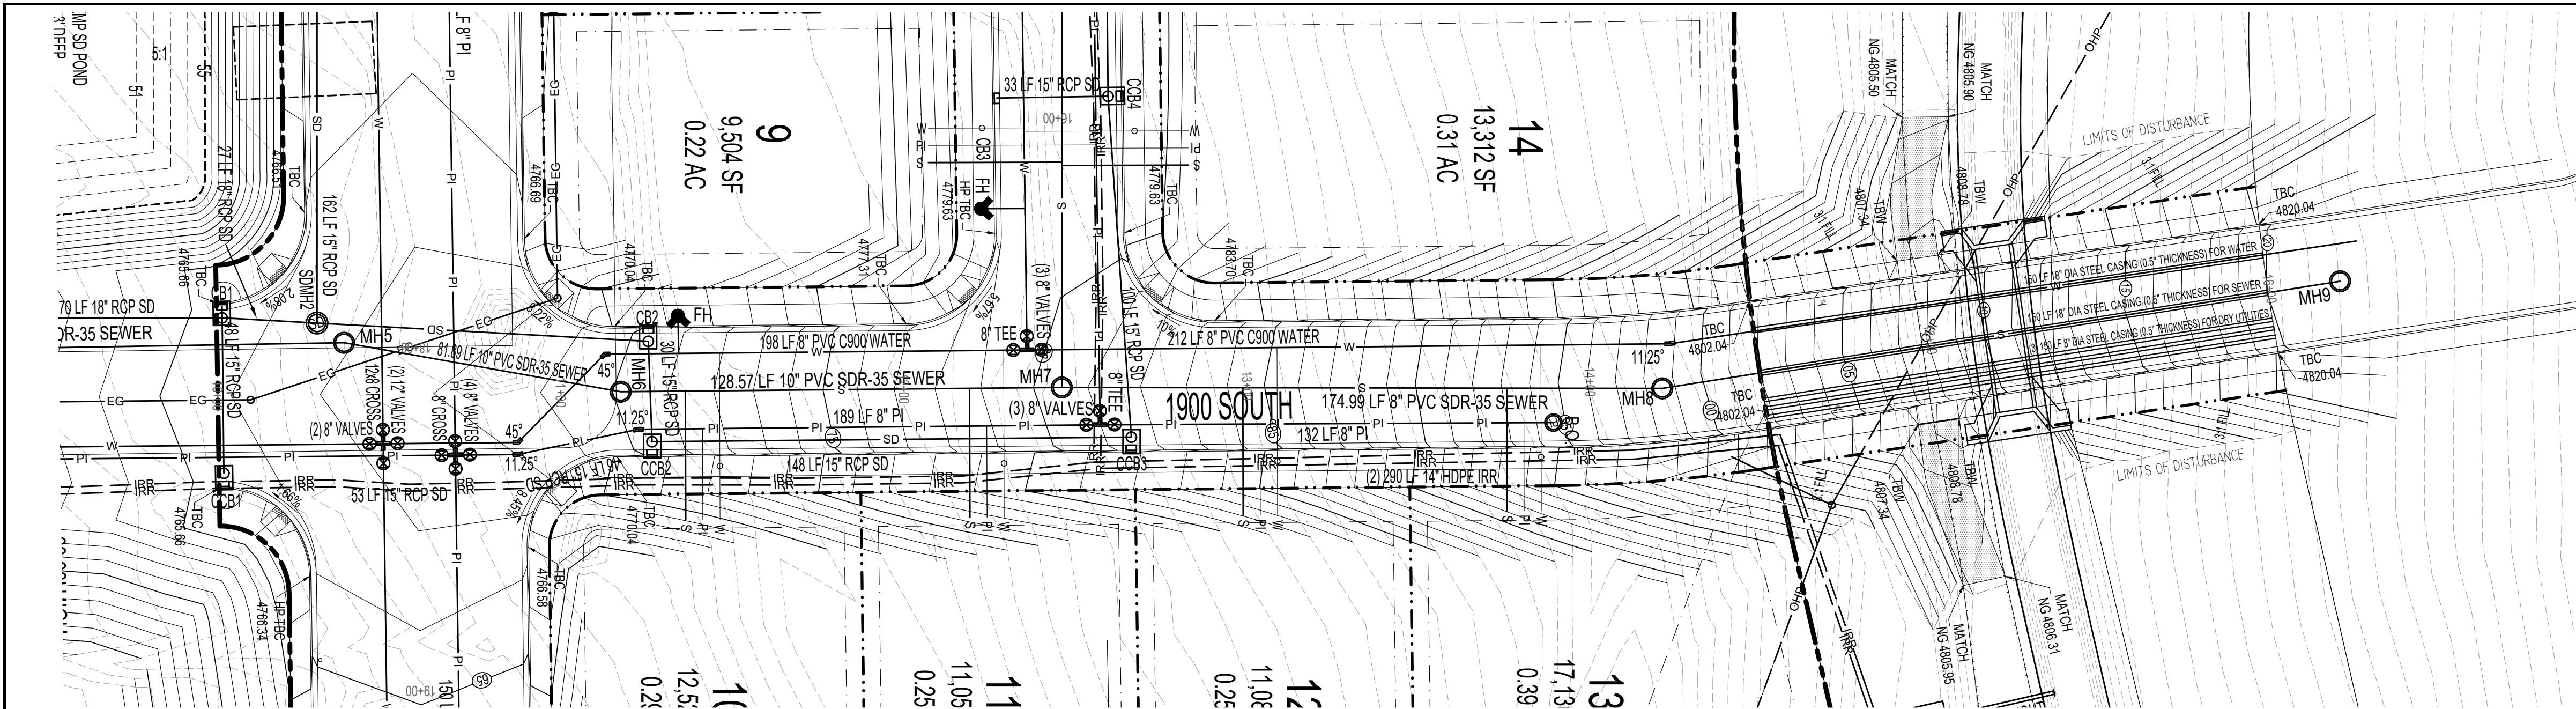CONSTRUCTION NOTES

ALL CONSTRUCTION TO CONFORM TO
PAYSON CITY OR APWA STADARD DETAILS

A STORM WATER MANAGEMENT PLAN
WILL BE REQUIRED PRIOR TO
CONSTRUCTION

DRAINAGE CALCULATIONS

REFER TO SHEET C3.2 FOR STORM
DRAINAGE CALCULATIONS FOR
TEMPORARY POND


SURVEY CONTROL

SITE BENCHMARK
EAST QUARTER CORNER OF SEC 20,T9S, R2E, SLB8M
B.M. ELEVATION = 4836.30

BASIS OF BEARING
N 89°35'10" E BETWEEN THE NORTHWEST AND
NORTH QUARTER CORNERS OF SECTION 21,T9S, R2E,
SLB8M

DISTURBED AREA

TOTAL AREA OF DISTURBANCE WITHIN THE CANAL
RIGHT-OF-WAY = 0.36 AC

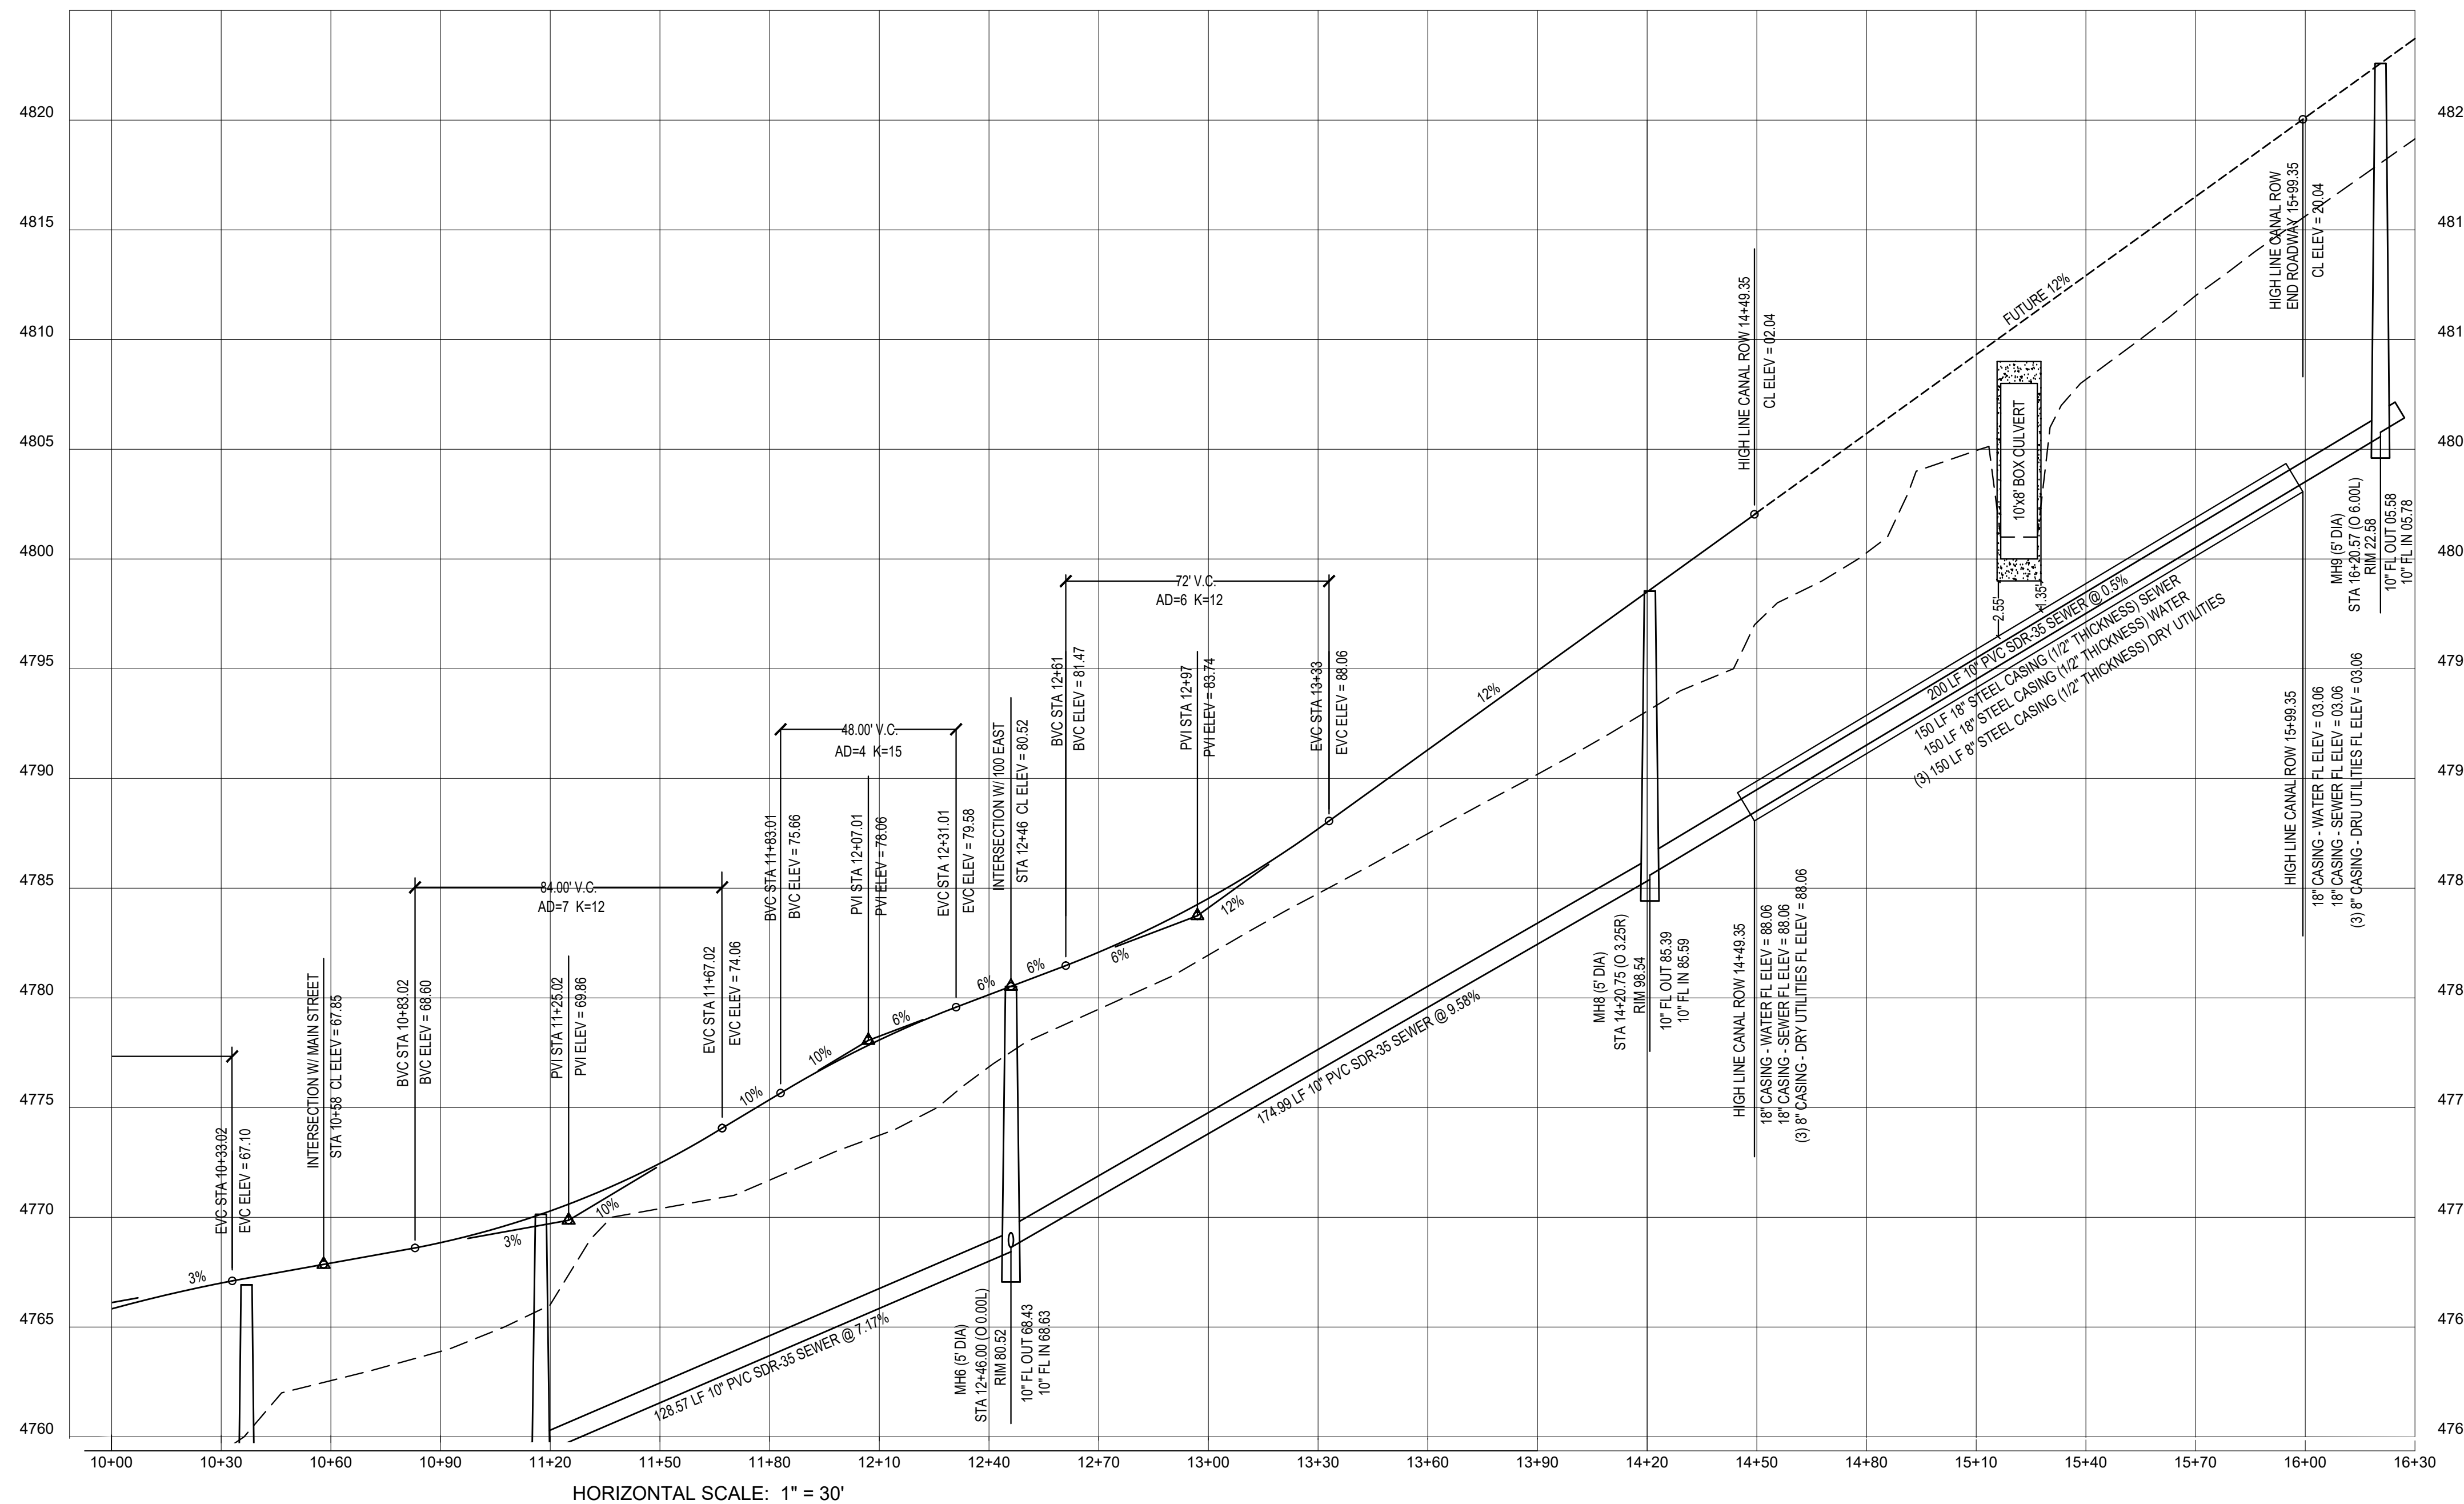

BOR Drawing Number:

27-418-60044-MF-1

KEN R. BERG, P.E.
DRAWN

JEREMY FOWLER, P.E.
ACCEPTED

418 (PROVO, UT)

2023-11-08


DEVELOPMENT

PAYSON VIEW ESTATES PHASE 4

DEVELOPER



11038 N. Highland Blvd Suite 100
Highland, UT 84003
(801) 642-0119

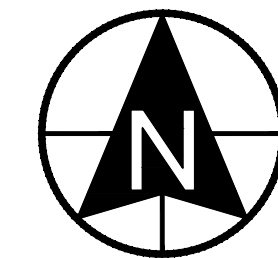

0 15 30 60 90
SCALE: 1"= 30'



1018 N. Deer Crest Lane
Alpine, UT, 84004
office (801) 492-1277
cell (801) 616-1677

REVISIONS			SEAL
NO.	DATE	DESCRIPTION	
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ACTION	DATE
PRELIM	01/16/2024

PROJECT

PAYSON VIEW ESTATES PHASE 4


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PRELIMINARY PLANS

SHEET NAME

SHEET NUMBER

1900 S C4.4

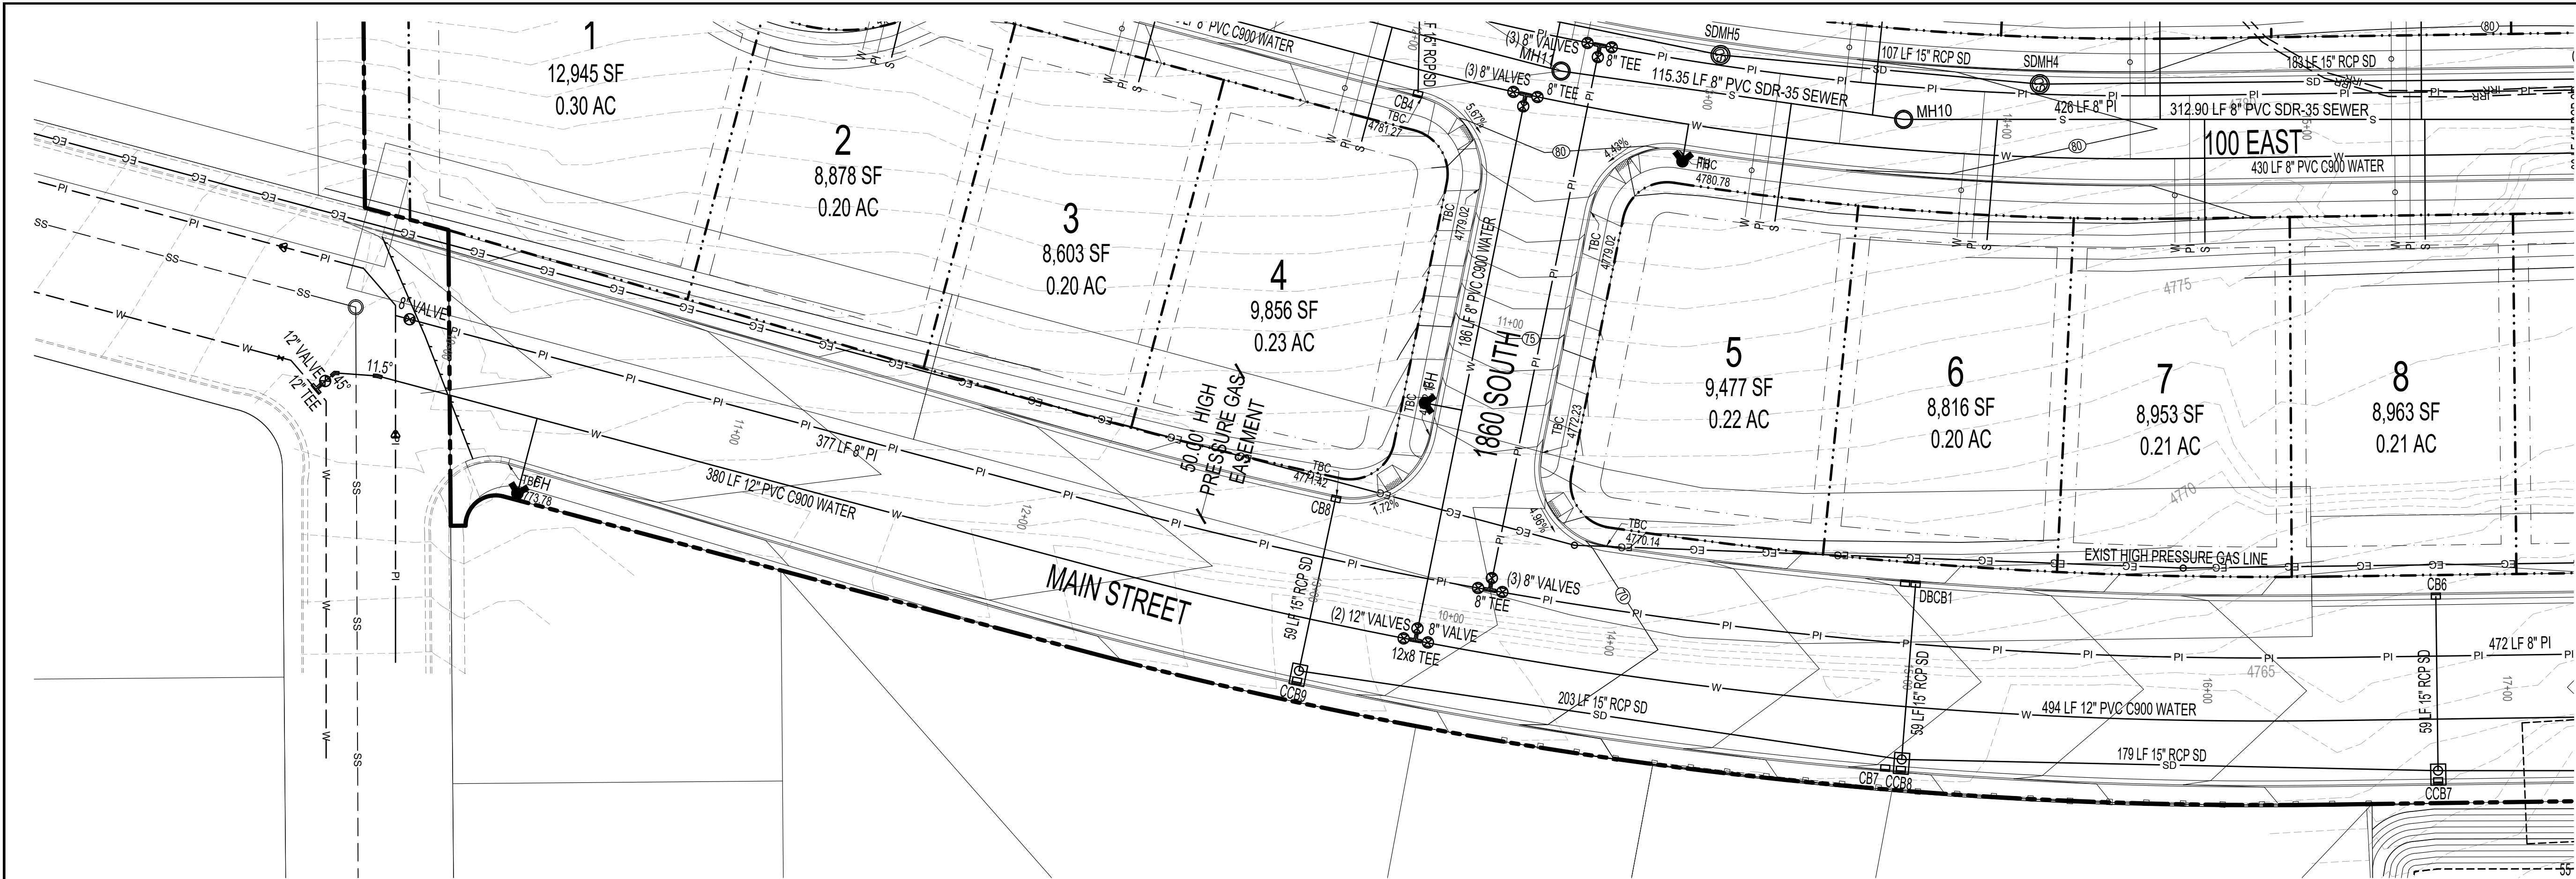

CONSTRUCTION NOTES

ALL CONSTRUCTION TO CONFORM TO
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DRAINAGE CALCULATIONS


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DRAINAGE CALCULATIONS FOR
TEMPORARY POND

SURVEY CONTROL

SITE BENCHMARK
EAST QUARTER CORNER OF SEC. 20, T9S, R2E, SLB8M
B.M. ELEVATION = 4836.30

BASIS OF BEARING
N 89°35'10" E BETWEEN THE NORTHWEST AND
NORTH QUARTER CORNERS OF SECTION 20, T9S, R2E,
SLB8M

MAIN STREET

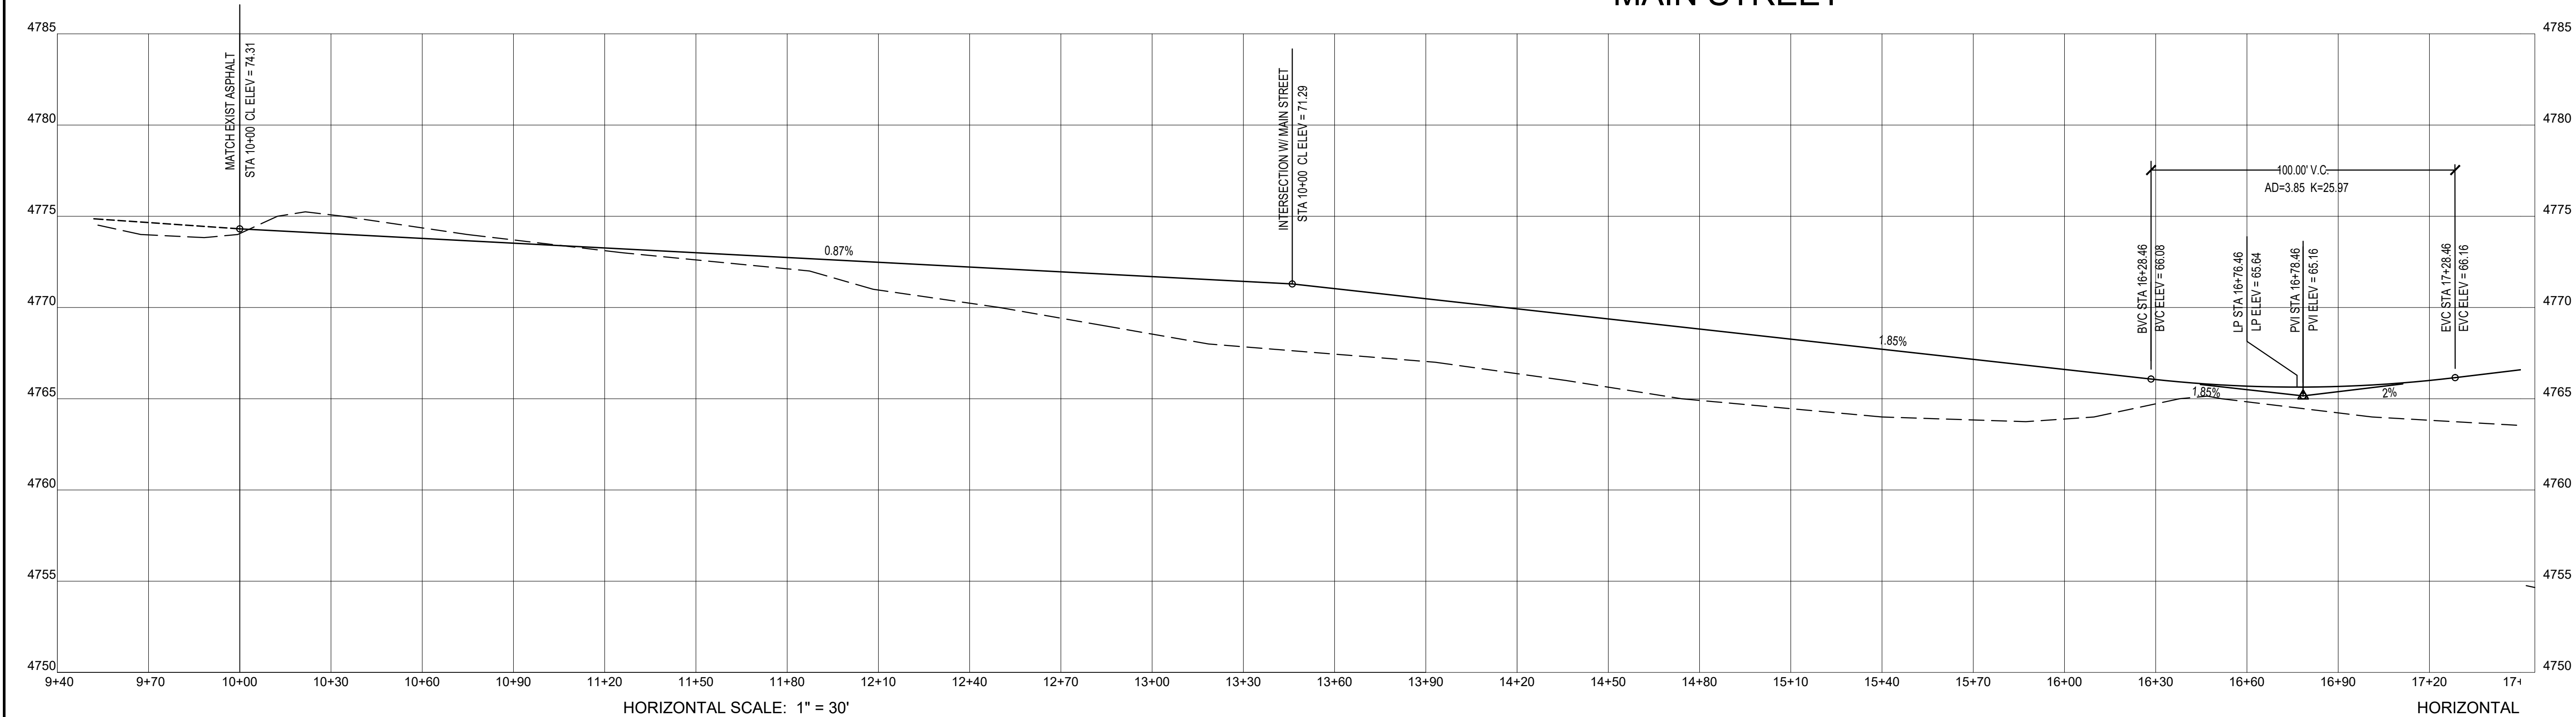


DEVELOPMENT

PAYSON VIEW ESTATES PHASE 4

DEVELOPER



11038 N. Highland Blvd Suite 100
Highland, UT 84003
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0 15 30 60 90
SCALE: 1"= 30'

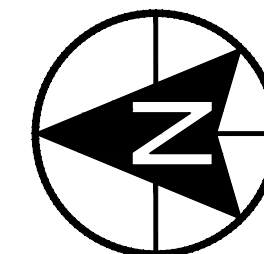

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ACTION	DATE
PRELIM	01/16/2024

PROJECT


PAYSON VIEW ESTATES PHASE 4

DESCRIPTION

PRELIMINARY PLANS

SHEET NAME SHEET NUMBER

MAIN C5.1

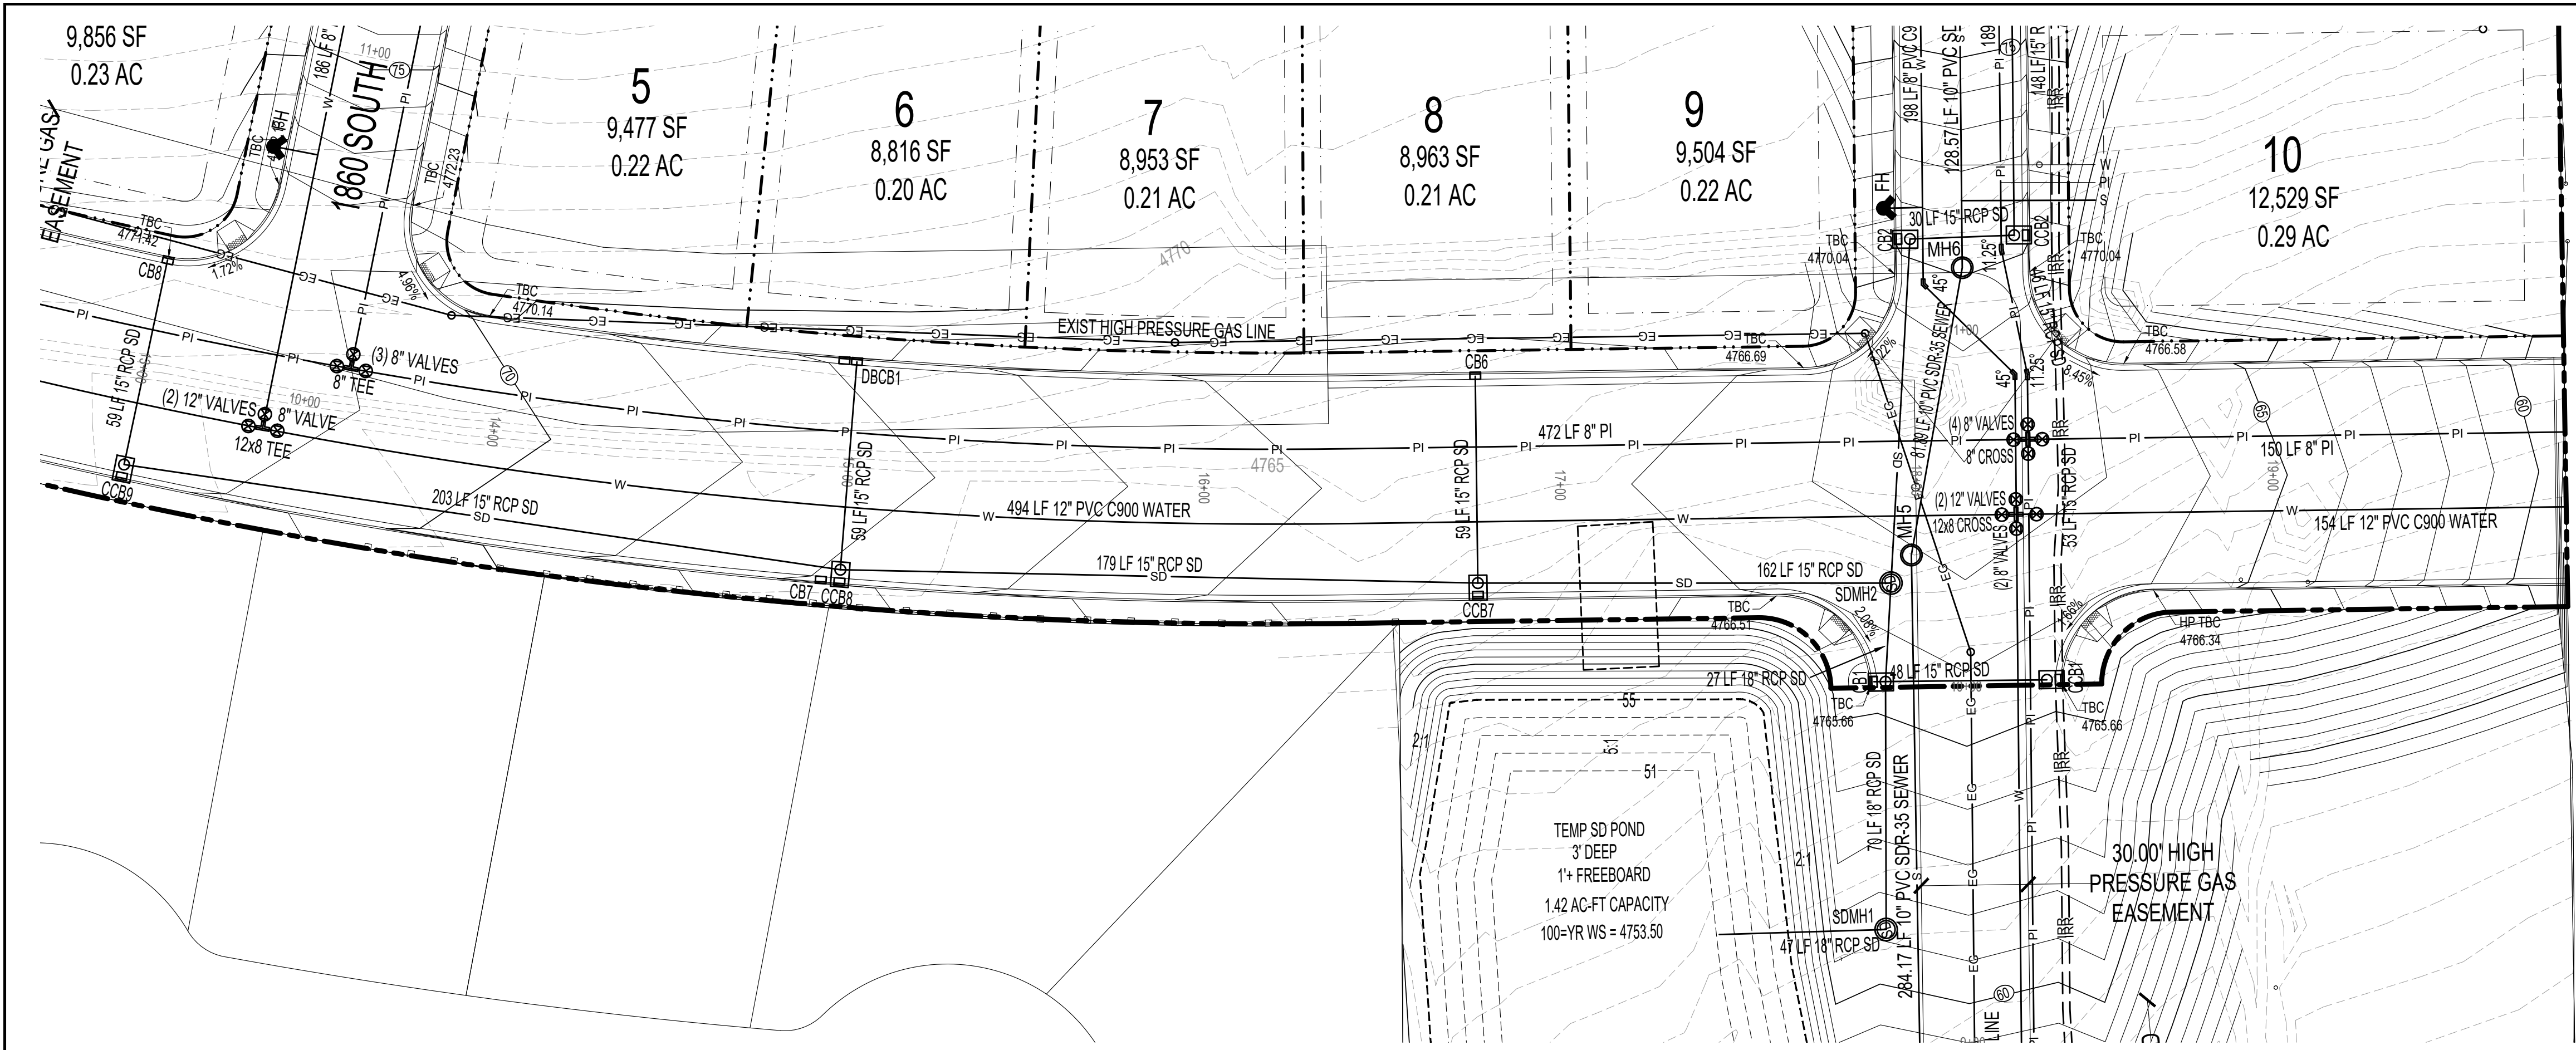

CONSTRUCTION NOTES

ALL CONSTRUCTION TO CONFORM TO
PAYSON CITY OR APWA STADARD DETAILS

A STORM WATER MANAGEMENT PLAN
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CONSTRUCTION

DRAINAGE CALCULATIONS


REFER TO SHEET C3.2 FOR STORM
DRAINAGE CALCULATIONS FOR
TEMPORARY POND

SURVEY CONTROL

SITE BENCHMARK
EAST QUARTER CORNER OF SEC. 20,T9S, R2E, SLB8M
B.M. ELEVATION = 4836.50

BASIS OF BEARING
N 89°35'10" E BETWEEN THE NORTHWEST AND
NORTH QUARTER CORNERS OF SECTION 20,T9S, R2E,
SLB8M

MAIN STREET

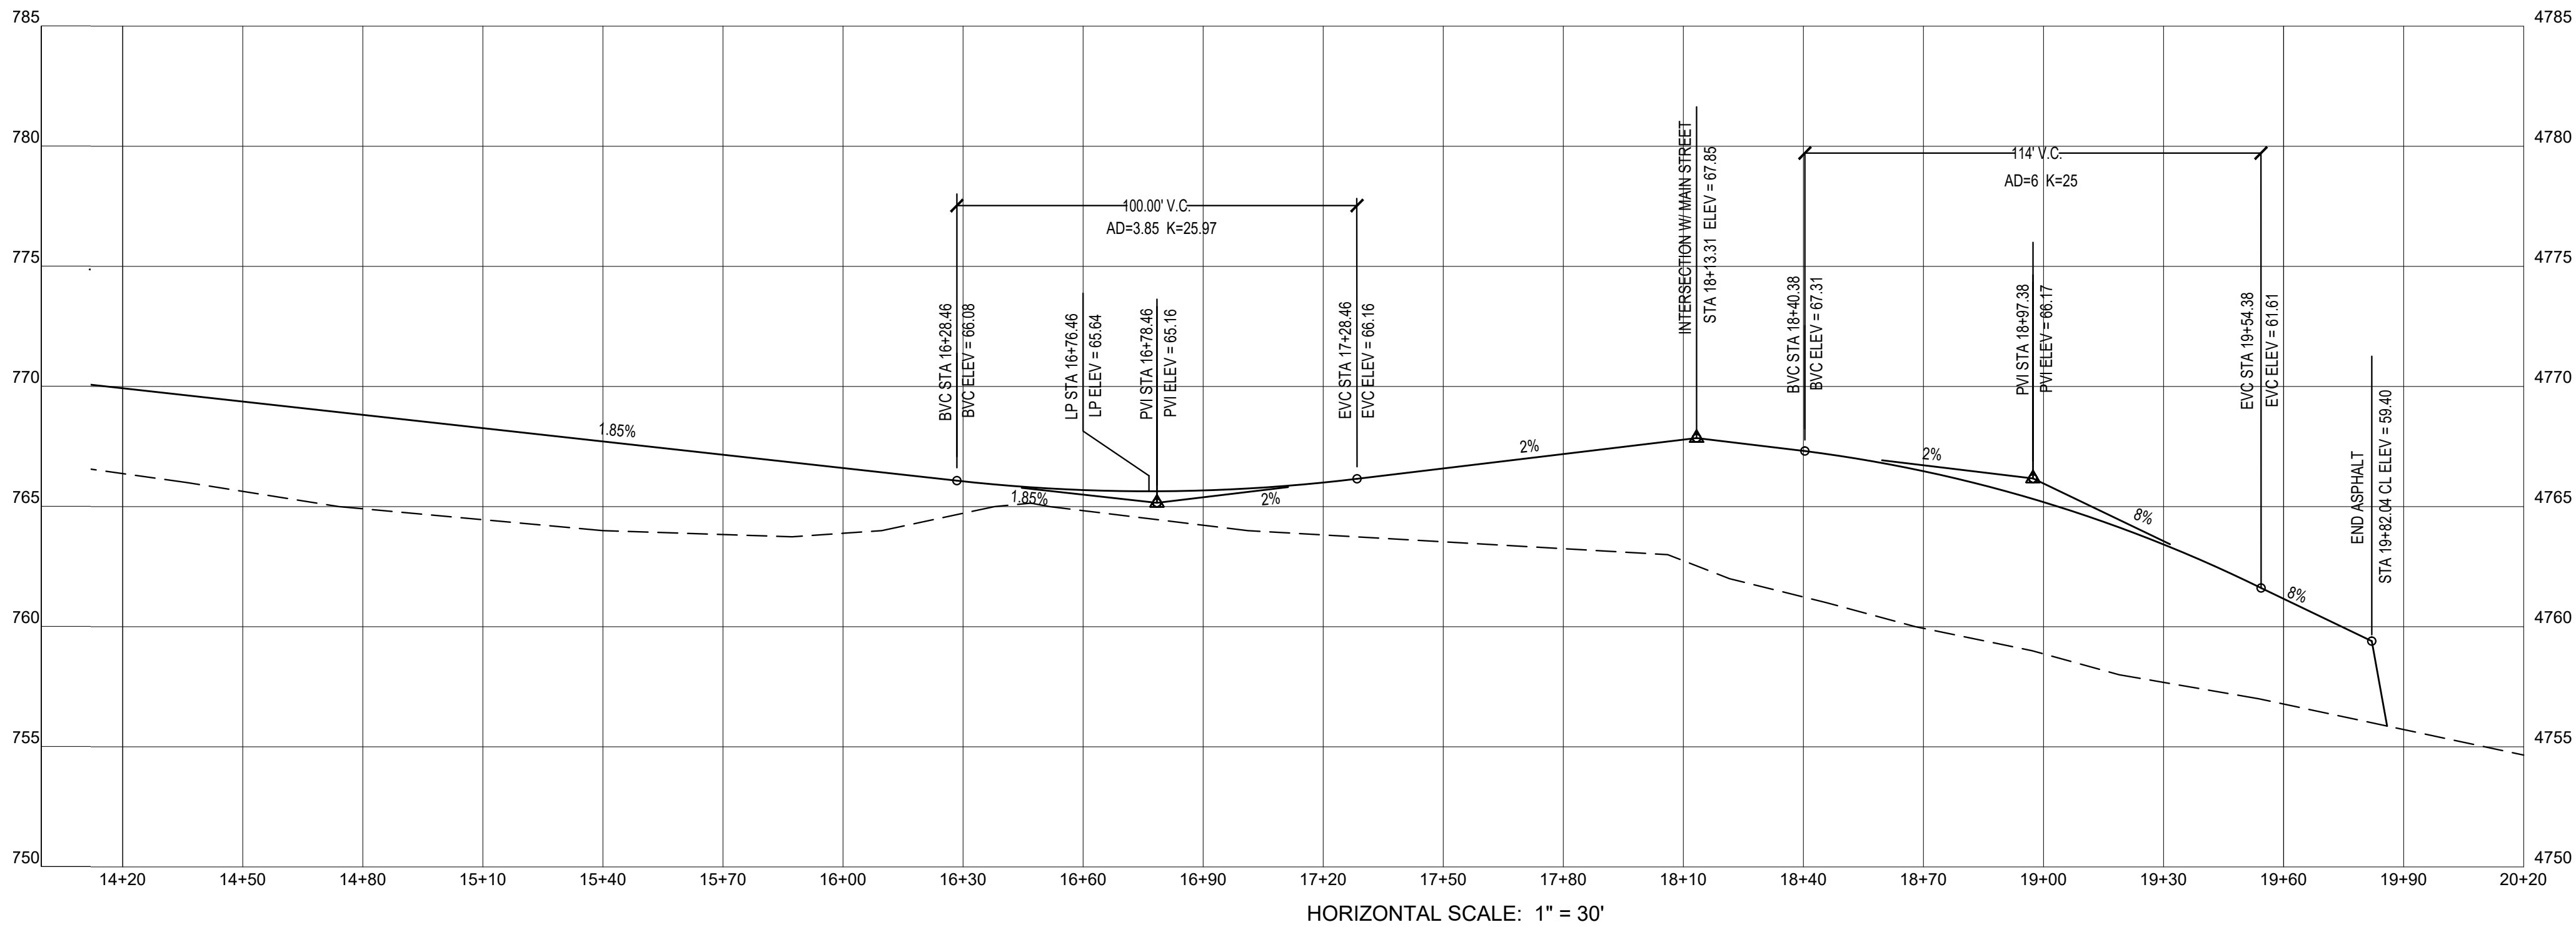


DEVELOPMENT

PAYSON VIEW ESTATES PHASE 4

DEVELOPER



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Highland, UT 84003
(801) 642-0119

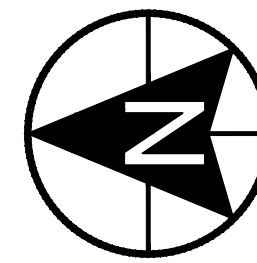

0 15 30 60 90
SCALE: 1"= 30'



REVISIONS			SEAL
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ACTION	DATE
PRELIM	01/16/2024

PROJECT

PAYSON VIEW ESTATES PHASE 4


DESCRIPTION

PRELIMINARY PLANS

SHEET NAME

MAIN C5.2

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CONSTRUCTION NOTES

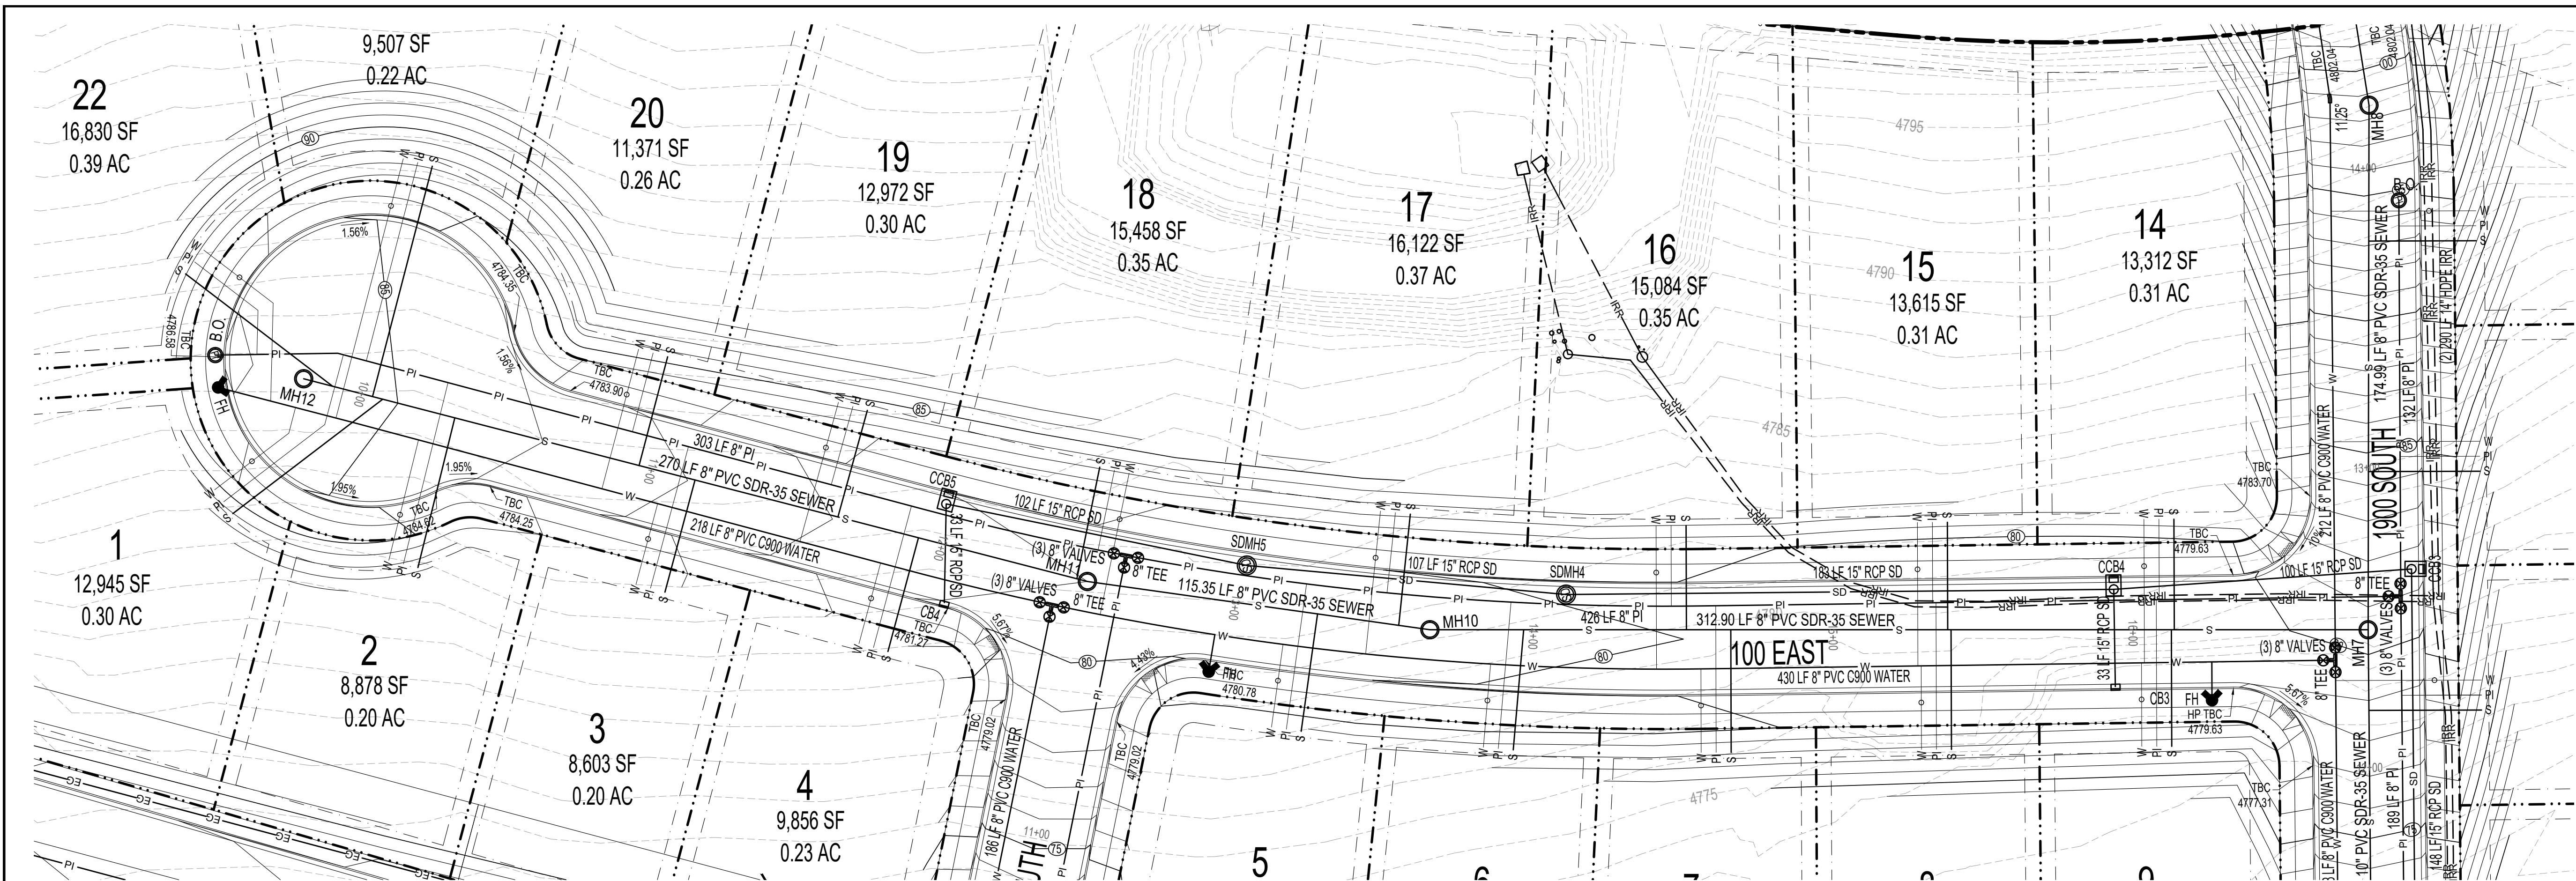ALL CONSTRUCTION TO CONFORM TO
PAYSON CITY OR APWA STADARD DETAILS

A STORM WATER MANAGEMENT PLAN
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DRAINAGE CALCULATIONS


REFER TO SHEET C3.2 FOR STORM
DRAINAGE CALCULATIONS FOR
TEMPORARY POND

SURVEY CONTROL

SITE BENCHMARK
EAST QUARTER CORNER OF SEC. 20,T9S, R2E, SLB8M
B.M. ELEVATION = 4836.30

BASIS OF BEARING
N 89°35'10\"/>

100 EAST

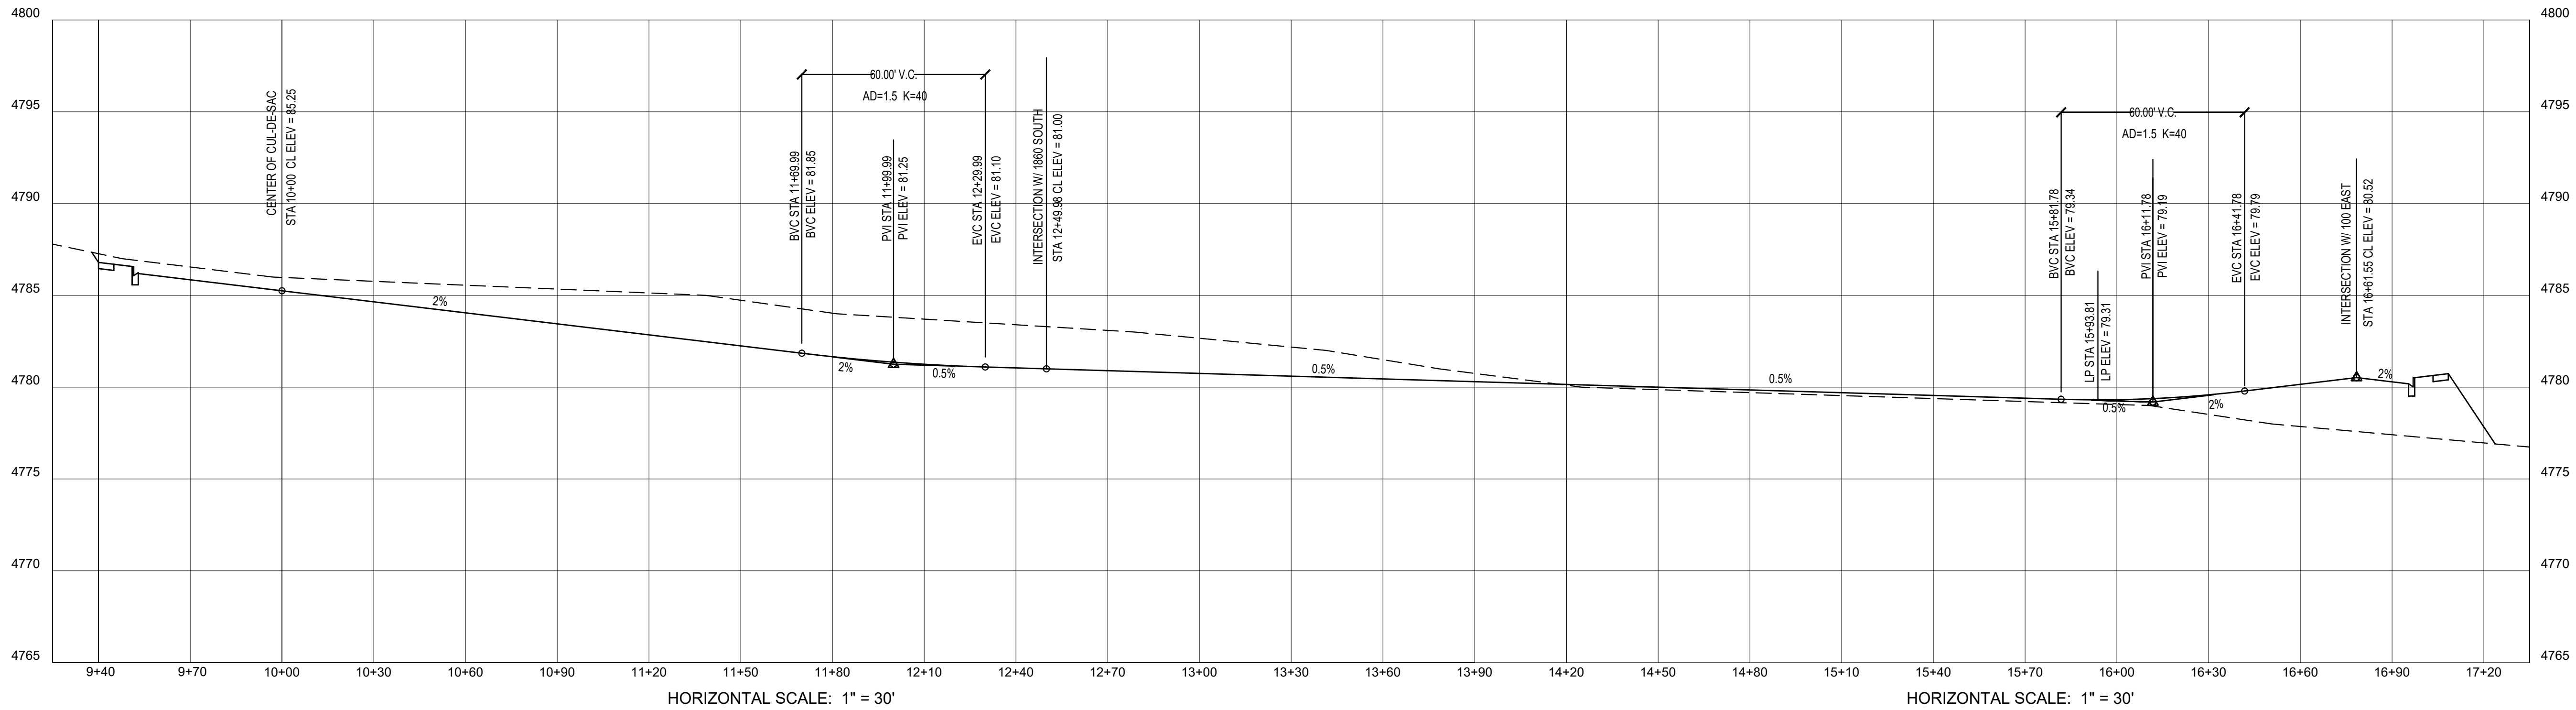


DEVELOPMENT

PAYSON
VIEW
ESTATES
PHASE 4

DEVELOPER



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0 15 30 60 90
SCALE: 1"= 30'

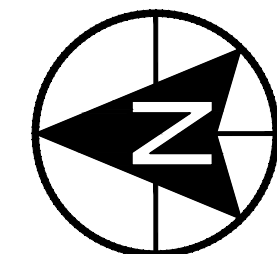

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PRELIM	01/16/2024

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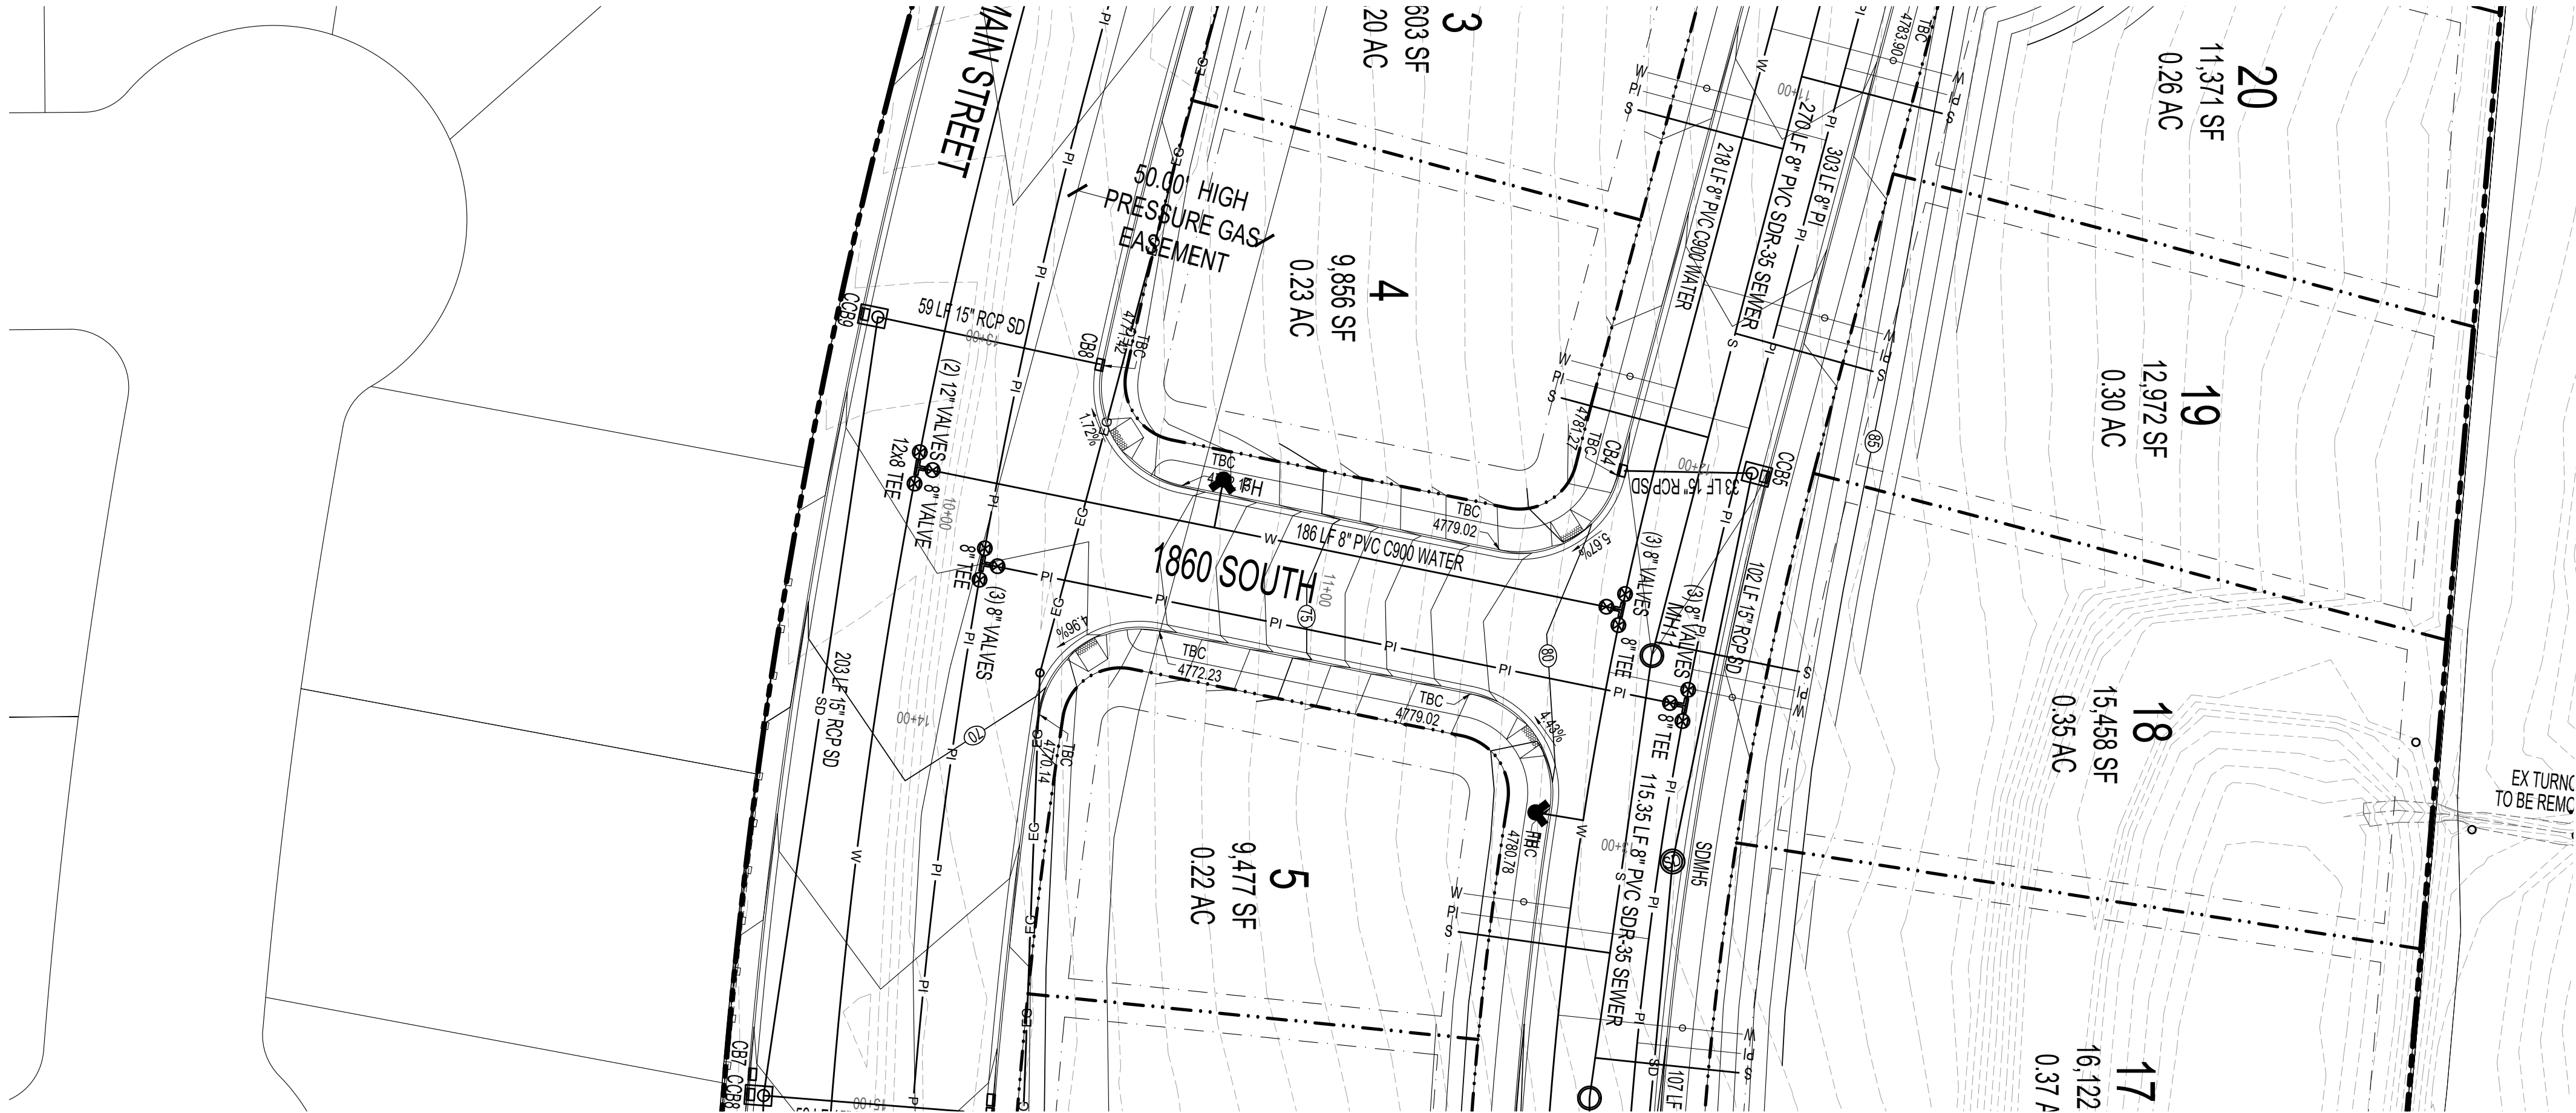
PAYSON VIEW
ESTATES
PHASE 4

DESCRIPTION

PRELIMINARY
PLANS

SHEET NAME SHEET NUMBER

100 E C6.1



CONSTRUCTION NOTES

ALL CONSTRUCTION TO CONFORM TO
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CONSTRUCTION

DRAINAGE CALCULATIONS

REFER TO SHEET C3.2 FOR STORM
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TEMPORARY POND

SURVEY CONTROL

SITE BENCHMARK
EAST QUARTER CORNER OF SEC 20,T9S, R2E, SLB8M
B.M. ELEVATION = 4836.30

BASIS OF BEARING
N 89°35'10" E BETWEEN THE NORTHWEST AND
NORTH QUARTER CORNERS OF SECTION 21,T9S, R2E,
SLB8M


DEVELOPMENT

PAYSON VIEW ESTATES PHASE 4

DEVELOPER



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PROJECT

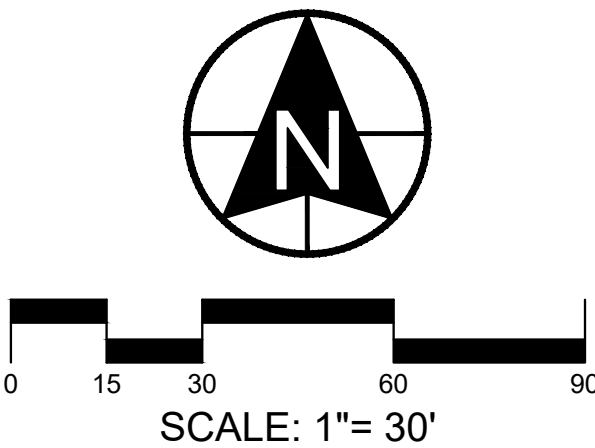
PAYSON VIEW ESTATES PHASE 4

DESCRIPTION

PRELIMINARY PLANS

SHEET NAME SHEET NUMBER

1860 S C7.1

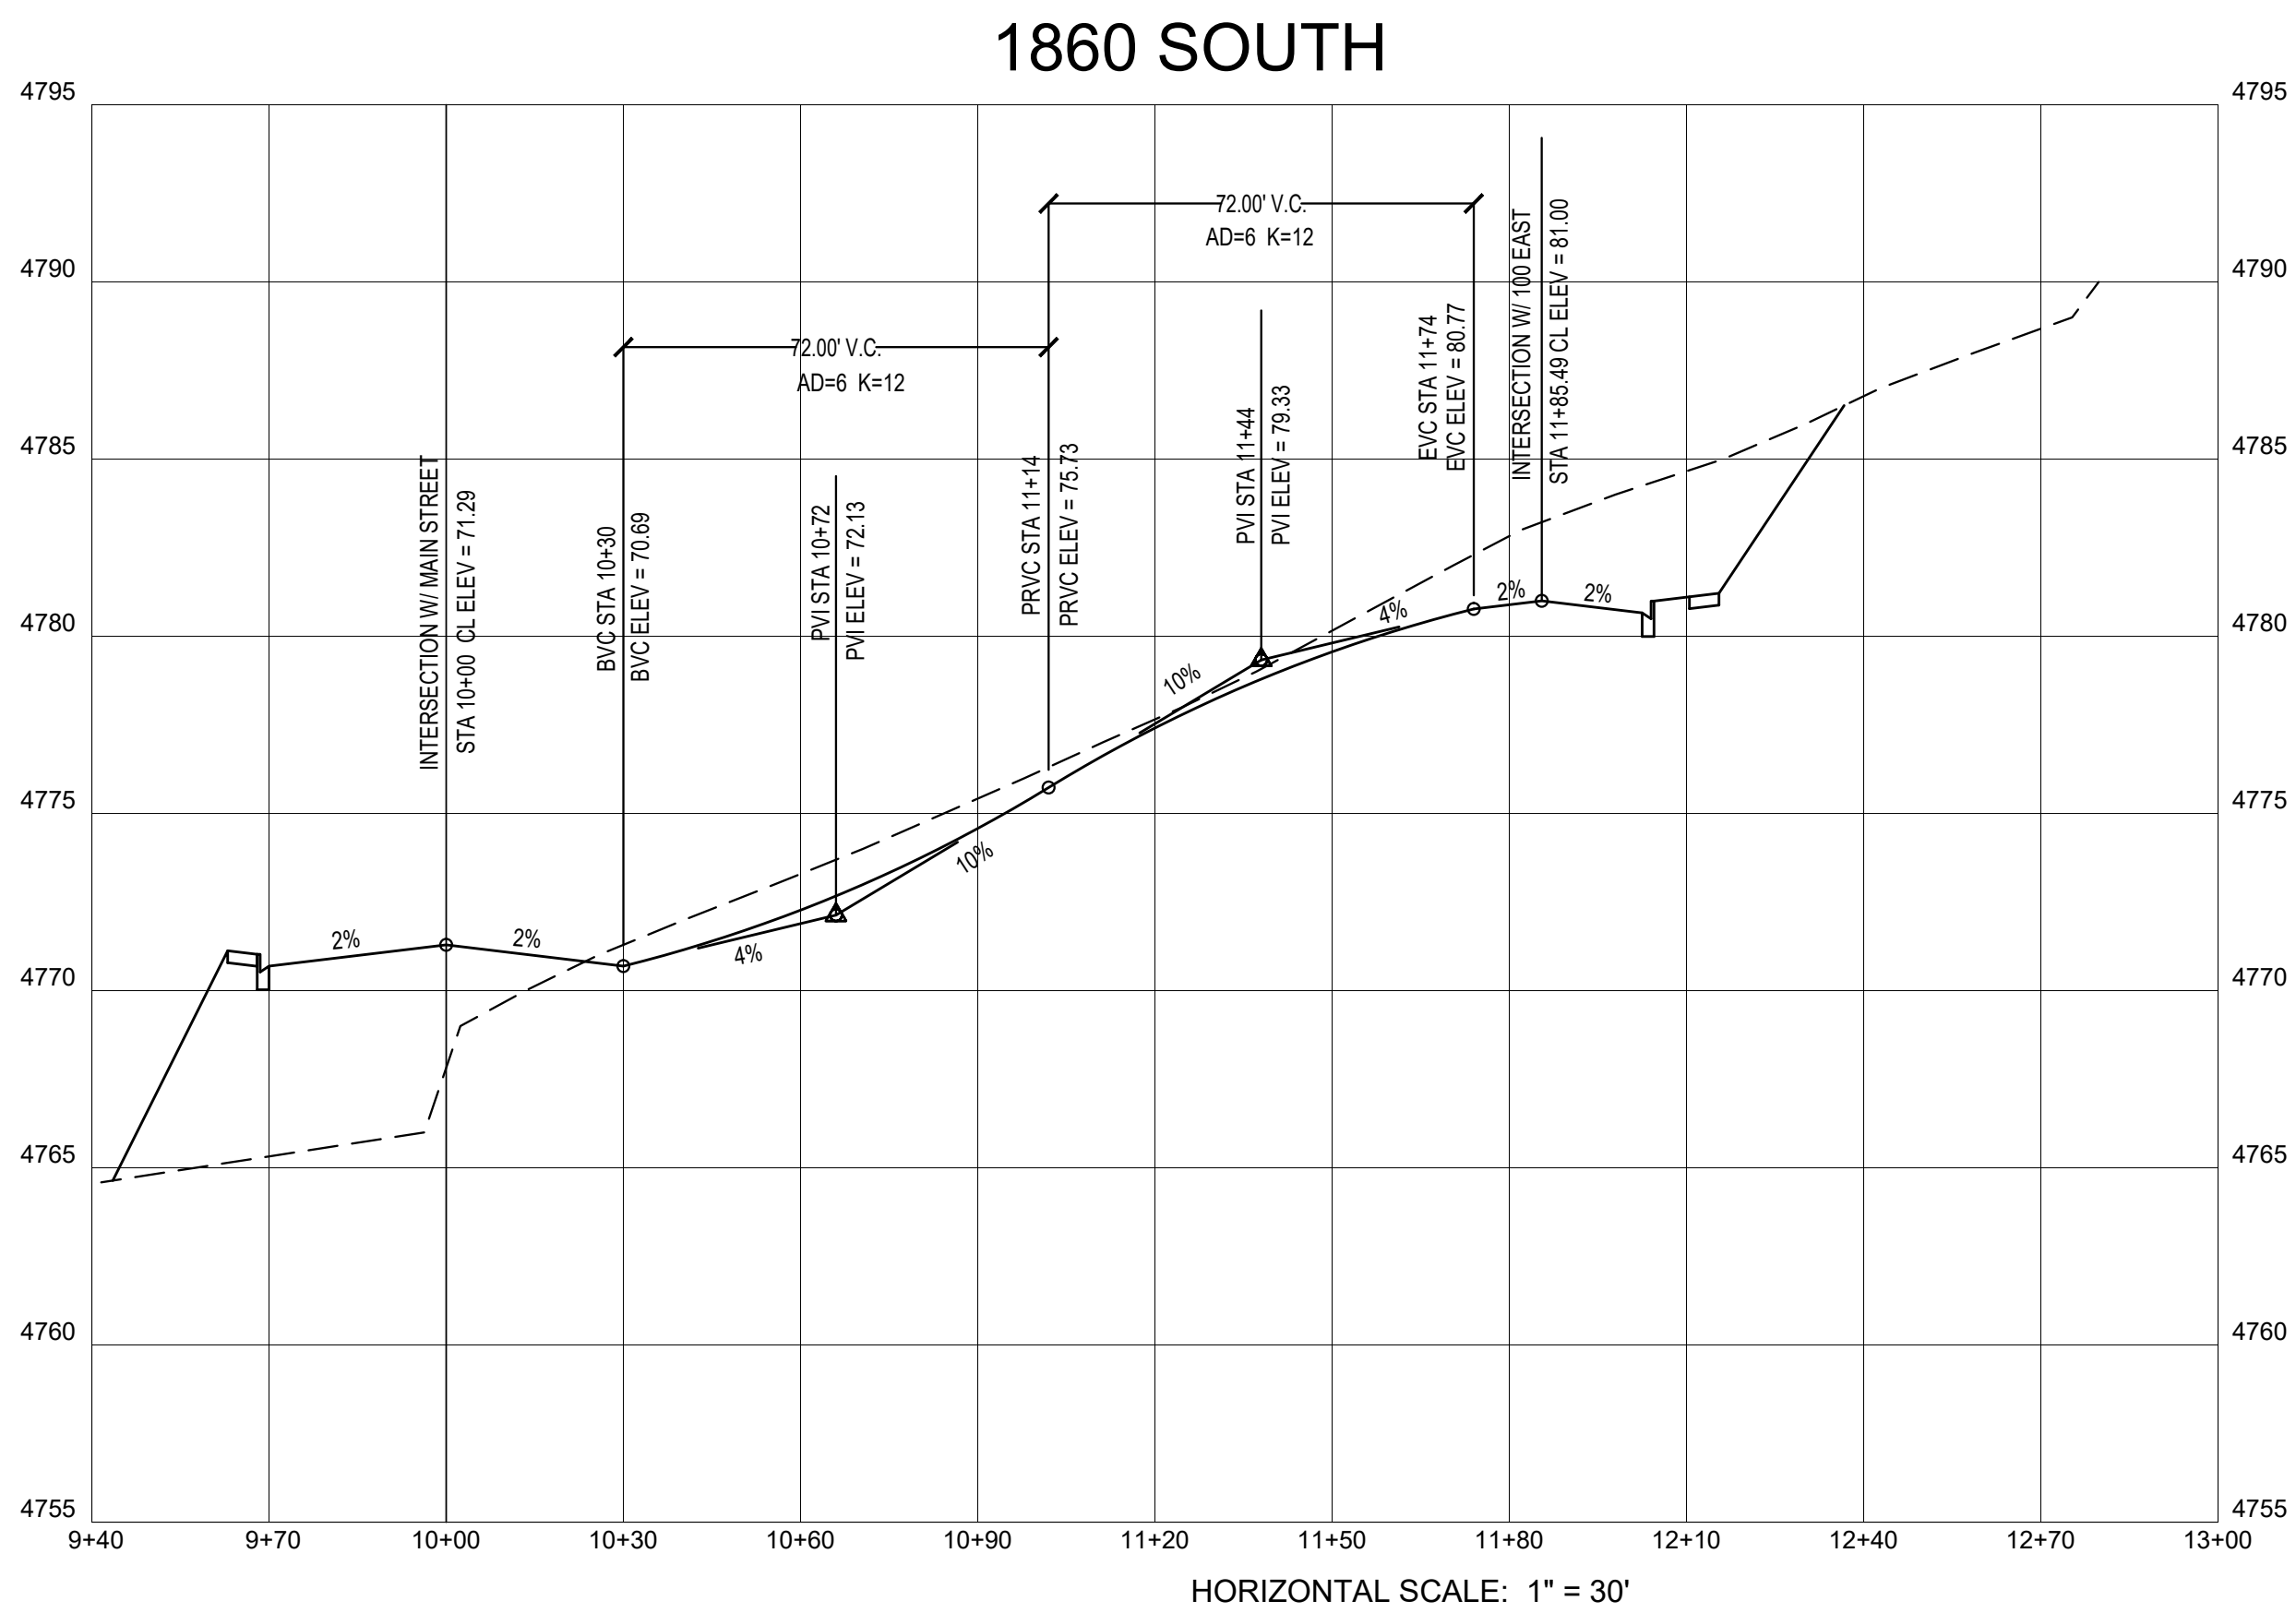

UTILITY DISCLAIMER

The locations, materials, slopes, flow line, rim elevations, and sizes of the existing underground or overhead utilities are shown as accurately as possible, but due to the age of the infrastructure and reporting errors the sizes and locations of the utilities shown on the Payson City GIS map are approximate and should not be used for design purposes. The owner and contractor of a development project are responsible for contacting Blue Stakes to locate all the existing utilities and performing pot holes to field verify the sizes, materials, and depths of the existing utilities prior to construction and ordering the correct materials to prevent errors in design sizes, materials, slopes, flow lines, and rim elevation shown on the GIS map. Failure to verify the sizes and ordering the building the wrong sized pipe or structure is the responsibility of the owner or contractor.

The engineering design of an open channel, pipe system, storm drainage detention/retention system, etc. should include hydraulics and hydrology calculations. Failure to comply with these requirements constitute Unprofessional Conduct under the Utah State Division of Professional Licensing rules and regulations.

INSPECTION, TESTING AND QUALITY CONTROL

- a. All construction work involving the installation of improvements in Payson City shall be subject to City inspections and testing as outlined in the quality control section of each specification.
- b. Request for inspection:
- i. Request for inspections shall be made to the Public Works Secretary by the person responsible for the construction.
- ii. Notice shall be given forty-eight (48) hours in advance of the work starting.
- iii. Any work shall be inspected prior to being backfilled or covered.
- c. Construction completion inspection:
- i. A final inspection shall be made by the Public Works Director, or a designee upon receipt of a request by the owner after all the construction work is completed.
- ii. Any faulty or defective work shall be corrected by the persons responsible for the work within a period of thirty (30) days from the date of the City Engineer's Inspection Report defining the faulty or defective work.
- d. Quality Control Testing:
- i. Material testing shall be conducted by an independent laboratory, approved by the Public Works Director, at the owner's expense. Material testing and inspection fees must be paid in full before requesting a pre- construction meeting.
- ii. All testing shall comply with the current ASTM, AASHTO, AWWA or Public Drinking Water Regulation standards and shall meet the minimum testing requirements as outlined in the specifications.
- iii. Personnel performing test shall have the appropriate certifications to perform such tests.
- iv. The cost of any and all re-testing required to bring materials into specification shall be borne by the owner.
- v. The time and locations of all test shall be approved by the Public Works Director's office.
- vi. If determined necessary by the Public Works Director or a designee, additional material testing can be required.
- e. Test report:
- i. Written test results will be required for review by the Public Works Director after each portion of the work (i.e. pipeline construction, earthwork, curb, gutter and sidewalk, roadway construction, etc.)

AS-BUILT DRAWINGS

- a. Before final inspection, the Contractor shall provide a complete set of as-built drawings that includes all items specified on the construction drawings.
- b. The as-built drawings shall show all improvement dimensions as constructed in the field.
- c. The as-built drawings shall be submitted on a flash drive saved on AutoCAD and Adobe Acrobat format.
- e. No bond retainer shall be released until as-built drawings are received by the Public Works Director.

GUARANTEE OF WORK

- a. The Owner shall warrant and guarantee that the improvements provided for hereunder, and every part thereof, will remain in good condition for a period of one (1) year after the date of the acceptance of the project by the City. Payson City Standard Detail PB 1 illustrates the process for posting performance guarantee bonds.
- b. The Owner shall make all the necessary repairs and maintain the improvements and every part thereof in good condition during the specified time at no cost to the City.
- c. The guarantee hereby stipulated shall extend to and include, but shall not be limited to:
- i. Road base.
- ii. Asphalt or concrete pavement.
- iii. All pipes.
- iv. Pipe joints.
- v. Valves.
- vi. Manholes.
- vii. Backfill
- viii. Curb
- ix. Gutters
- x. Sidewalks
- xi. Striping and signage.
- d. Whenever, in the judgment of the Public Works Director, said work shall be in need of repair, maintenance, or reconstruction, written notice shall be served upon the Owner and thereupon the Owner shall undertake and complete such repairs in a timely manner.
- e. If the Owner fails to do so within thirty (30) days from the date of the service of such notice, the Public Works Director shall have such repairs made and the cost of such repairs shall be paid by the Owner including any additional expenses incurred by the City.

TRAFFIC CONTROL AND ROAD CLOSURES

- a. The Contractor shall provide and maintain all necessary signs and barricades needed for traffic control according to the MUTCD guidelines, latest edition.
- b. All necessary precautions shall be taken to protect the work and to safeguard the public.
- c. Street road closures shall be approved by the City Engineer or his designee.
- d. Sidewalk closures shall include a walkable path for people with disabilities.

SURVEY MONUMENTS

- a. Standard survey control monuments shall be installed in all streets to be dedicated for public use.

UPDES STORMWATER PERMIT

- a. A UPDES (Utah Pollutant Discharge Elimination System) Permit from the State of Utah is required for all projects that disturb greater than 1 acre or are less than one (1) acre and part of common plan of development or sale that is greater than 1 acre.

BUILDING PERMITS

- a. No building permit shall be issued for a subdivision until:
- i. Road base is placed, graded, compacted, and approved on the entire road surface.
- ii. Curb and gutter is in place.
- iii. Street signs are installed.
- iv. All underground utilities are in place, accepted, and functional.
- v. Fire hydrants are installed and in full operation.
- vi. It is reasonable to expect the subdivision improvements to be completed prior to the occupancy of the buildings.

CERTIFICATE OF OCCUPANCY

- a. A developer shall not sell any portion of an approved development without informing the prospective buyer or builder that occupancy may not be obtained until all permanent improvements are installed and approved by the City.

PRE CONSTRUCTION MEETING

- a. All work completed in the right of way shall use a qualified contractor.
- i. Contractor shall be licensed in accordance with state laws.
- ii. The City may refuse a contractor from public works construction for any of the following reasons from the past 5 years:
- 1. Failure to pay suppliers or subcontractors on previous work.
- 2. Poor communication.
- 3. Threatening or intimidating communications.
- 4. Willful and deceptive efforts to perform defective or substandard work.
- 5. Defective or substandard work on previous projects.
- 6. Unethical acts.
- iii. Contractor shall have proper insurance.
- 1. Liability: One million dollars (\$1,000,000) per person, two million dollars (\$2,000,000) per event.
- 2. Workers Compensation Insurance.
- b. A preconstruction meeting is required on all development or public works construction projects.
- c. Verify the following:
- i. Land Disturbance Permit has been issued
- ii. Storm Water Pollution Prevention Plan is approved and UPDES NOI has been issued.
- iii. Other necessary permits have been obtained.
- iv. Conveyance of water rights to Payson City has been completed.
- v. Payment of inspection and material testing fees has been completed.
- vi. Payson Fire Department Review approval letter signed.
- vii. When applicable, developer agreements are signed and executed.
- viii. When applicable, final plat application is approved.
- ix. When applicable, performance guarantee bond has been posted.
- d. Attendance is required by contractor project manager, site supervisor(s), design engineer, consultants, significant subcontractors, significant suppliers, Public Works Director, Development Engineer, and City Inspectors.
- e. Discuss the following topics:
- i. Site supervisors and 24-hour contacts.
- ii. Compliance with OSHA guidelines.
- iii. Coordination.
- iv. Schedule.
- v. Required material testing submittals.
- vi. Geotechnical issues.
- vii. Survey issues.
- viii. Coordination of inspections.
- ix. Specifications & standards.
- x. Request for partial and final bond releases.

IMPROVEMENTS SEQUENCE

- a. City improvements shall be installed in the following sequence, unless otherwise directed by the Public Works Director:
- 1. Rough grading
- 2. Sanitary Sewer
- 3. Culinary Water
- 4. Pressurized Irrigation
- 5. Storm Sewer
- 6. Dry Utilities (In Public Right Of Way)
- 7. Sub Base
- 8. Curb and Gutter
- 9. Road Base
- 10. Asphalt
- 11. Dry Utilities (In Easements)
- 12. Sidewalks and Trails
- 13. Manholes and Valve Collars
- 14. Survey Monument
- 15. Street Signs
- 16. Street Lights
- 17. Clean Up
- b. Contractors and Developers shall ensure that all the improvement items previous to paving the road are installed, inspected, surveyed, and approved by the City Inspector.
- c. No road cut permits will be issued on new City streets for five (5) years from the date the street was accepted by the City.

DEVELOPMENT

PAYSON
VIEW
ESTATES
PHASE 4

DEVELOPER



11038 N. Highland Blvd Suite 100
Highland, UT 84003
(801) 642-0119



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1			THIS DOCUMENT IS INCOMPLETE AND IS RELEASED TEMPORARILY FOR INTERIM REVIEW ONLY. IT IS NOT INTENDED FOR CONSTRUCTION, BIDDING, OR PERMIT PURPOSES. KENNETH R. BERG P.E. SERIAL NO. 343602 DATE: 01/16/2024
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ACTION	DATE
PRELIM	01/16/2024

PROJECT

PAYSON VIEW
ESTATES
PHASE 4

DESCRIPTION

PRELIMINARY
PLANS

SHEET NAME	SHEET NUMBER
NOTES	GN1

