




BOR Drawing Number:
27-418-60041-MF-1

KEN R. BERG, P.E.
 DRAWN

JEREMY FOWLER, P.E.
 ACCEPTED

418 (PROVO, UT) 2023-11-08

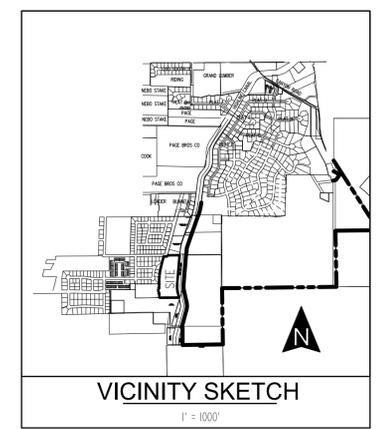

CONSTRUCTION NOTES
 ALL CONSTRUCTION TO CONFORM TO PAYSON CITY OR APWA STANDARD DETAILS

ABBREVIATION KEY

BOW	BACK OF SIDEWALK
CB	CATCH BASIN
EOA	EDGE OF ASPHALT
FL	FLOWLINE
FF	FINISHED FLOOR ELEVATION
HP	HIGH POINT
LP	LOW POINT
RM	MANHOLE RIM OR CATCH BASIN GRATE
TBC	TOP BACK OF CURB

SHEET INDEX

C0	COVER SHEET
C1	LAYOUT
C2.1	WATER PLAN
C2.2-C2.3	SEWER PLAN
C2.4	POWER PLAN
C2.5	FIRE PLAN
C3.1	GRADING & DRAINAGE PLAN
C3.2	TEMP SD RETENTION POND & CALCS
C4.1-C4.4	1900 SOUTH PLAN & PROFILE
C5.1-C5.2	MAIN STREET PLAN & PROFILE
C6.1	100 EAST PLAN & PROFILE
C7.1	1860 SOUTH PLAN & PROFILE
GNI	GENERAL NOTES
DTL1-DTL2	CONSTRUCTION DETAILS

CONTACT LIST


CIVIL ENGINEER	BERG CIVIL ENGINEERING	(801) 492-1277
GEOTECHNICAL ENGINEER		

DEVELOPMENT

PAYSON VIEW ESTATES PHASE 4

DEVELOPER

11038 N. Highland Blvd Suite 100
 Highland, UT 84003
 (801) 642-0119

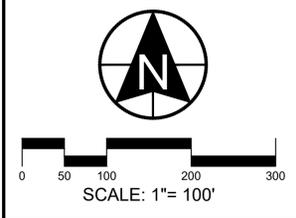

1018 N. Deer Crest Lane
 Alpine UT, 84004
 office (801) 492-1277
 cell (801) 616-1677

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ACTION	DATE
PRELIM	01/16/2024

PROJECT

PAYSON VIEW ESTATES PHASE 4

DESCRIPTION

PRELIMINARY PLANS

SHEET NAME	SHEET NUMBER
COVER	C0




DEVELOPMENT

PAYSON VIEW ESTATES PHASE 4

DEVELOPER



11038 N. Highland Blvd Suite 100
Highland, UT 84003
(801) 642-0119

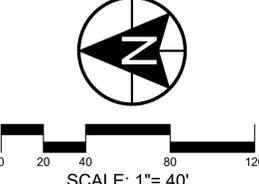

SCALE: 1" = 40'



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1		THIS DOCUMENT IS INCOMPLETE AND IS RELEASED TEMPORARILY FOR INTERIM REVIEW ONLY. IT IS NOT INTENDED FOR CONSTRUCTION, BIDDING, OR PERMIT PURPOSES.
2		
3		
4		KENNETH R. BERG P.E.
5		SERIAL NO. 343602
6		DATE: 01/16/2024
7		

ACTION	DATE
PRELIM	01/16/2024

PROJECT


PAYSON VIEW ESTATES PHASE 4

DESCRIPTION

PRELIMINARY PLANS

SHEET NAME	SHEET NUMBER
LAYOUT	C1

MOWER

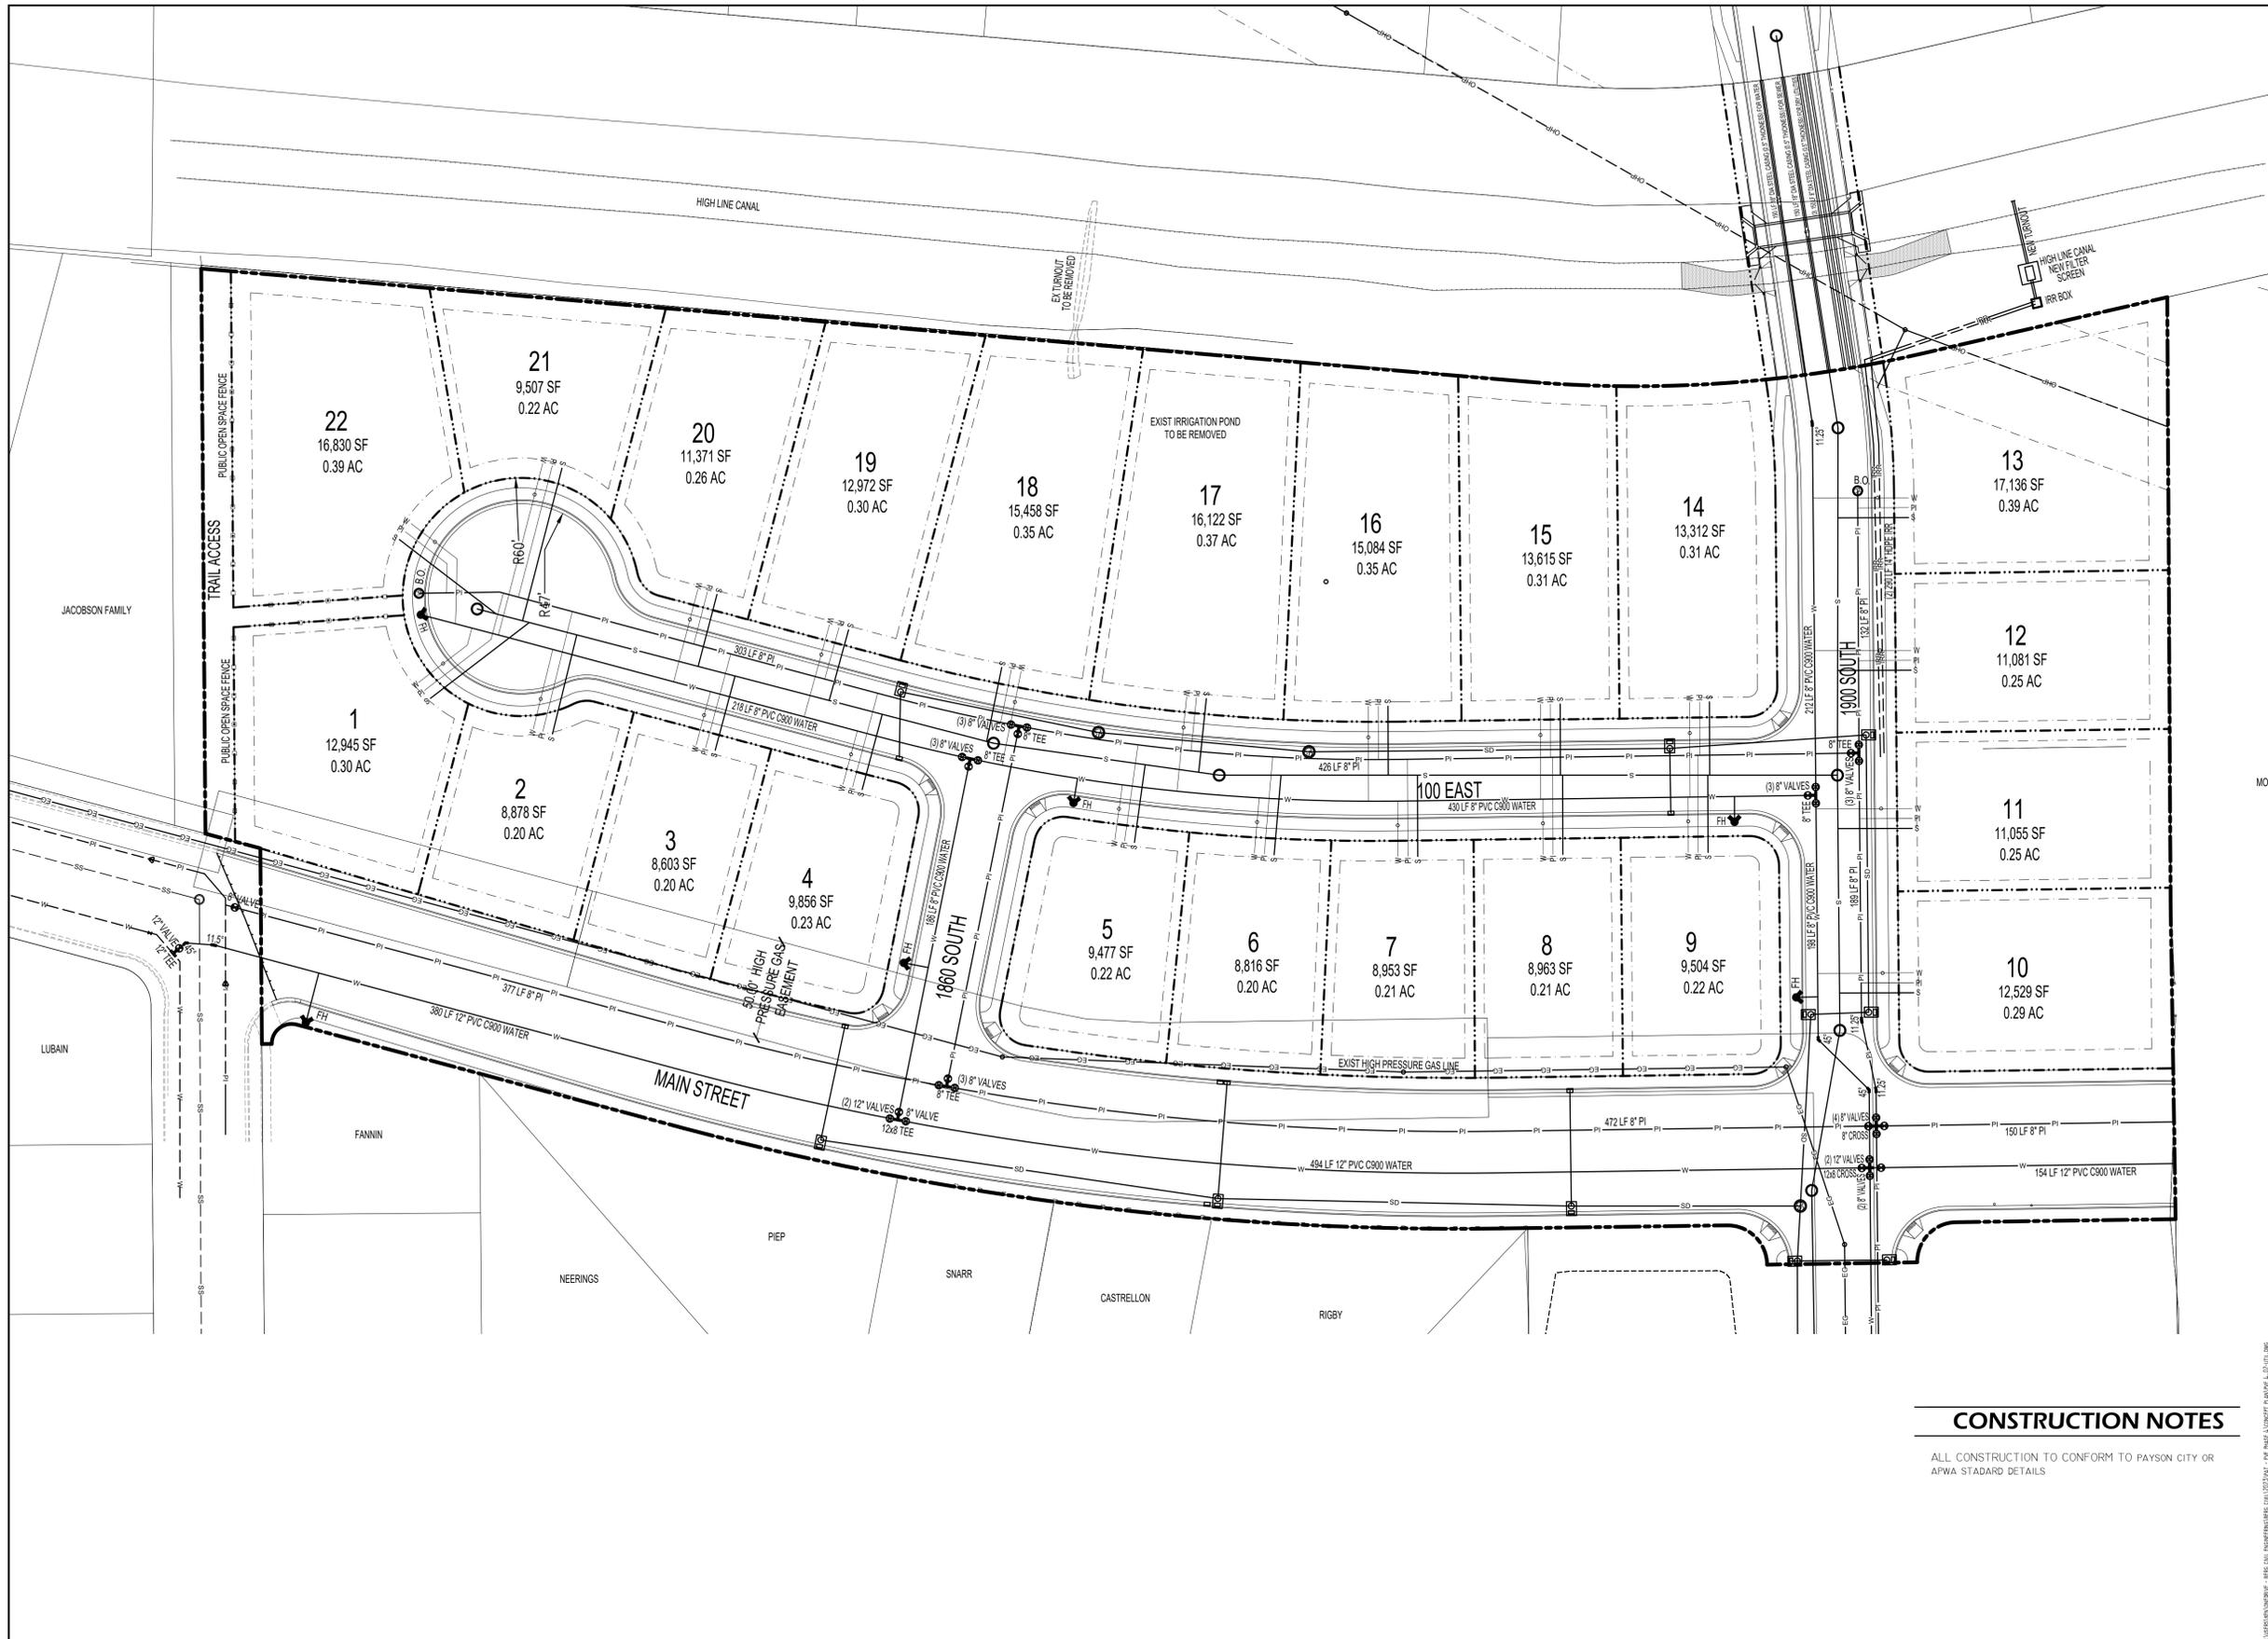


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SCALE: 1" = 40'



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PROJECT

PAYSON VIEW ESTATES PHASE 4

DESCRIPTION

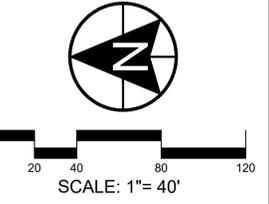PRELIMINARY PLANS

SHEET NAME	SHEET NUMBER
WATER	C2.1

CONSTRUCTION NOTES

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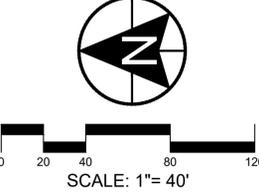
CONSTRUCTION NOTES
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DEVELOPMENT
**PAYSON
 VIEW
 ESTATES
 PHASE 4**

DEVELOPER



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PRELIM	01/16/2024

PROJECT
**PAYSON VIEW
 ESTATES
 PHASE 4**

DESCRIPTION
**PRELIMINARY
 PLANS**

SHEET NAME	SHEET NUMBER
SEWER	C2.2

CONSTRUCTION NOTES

ALL CONSTRUCTION TO CONFORM TO PAYSON CITY OR APWA STANDARD DETAILS

DEVELOPMENT

**PAYSON
VIEW
ESTATES
PHASE 4**

DEVELOPER



11038 N. Highland Blvd Suite 100
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0 20 40 80 120
SCALE: 1" = 40'



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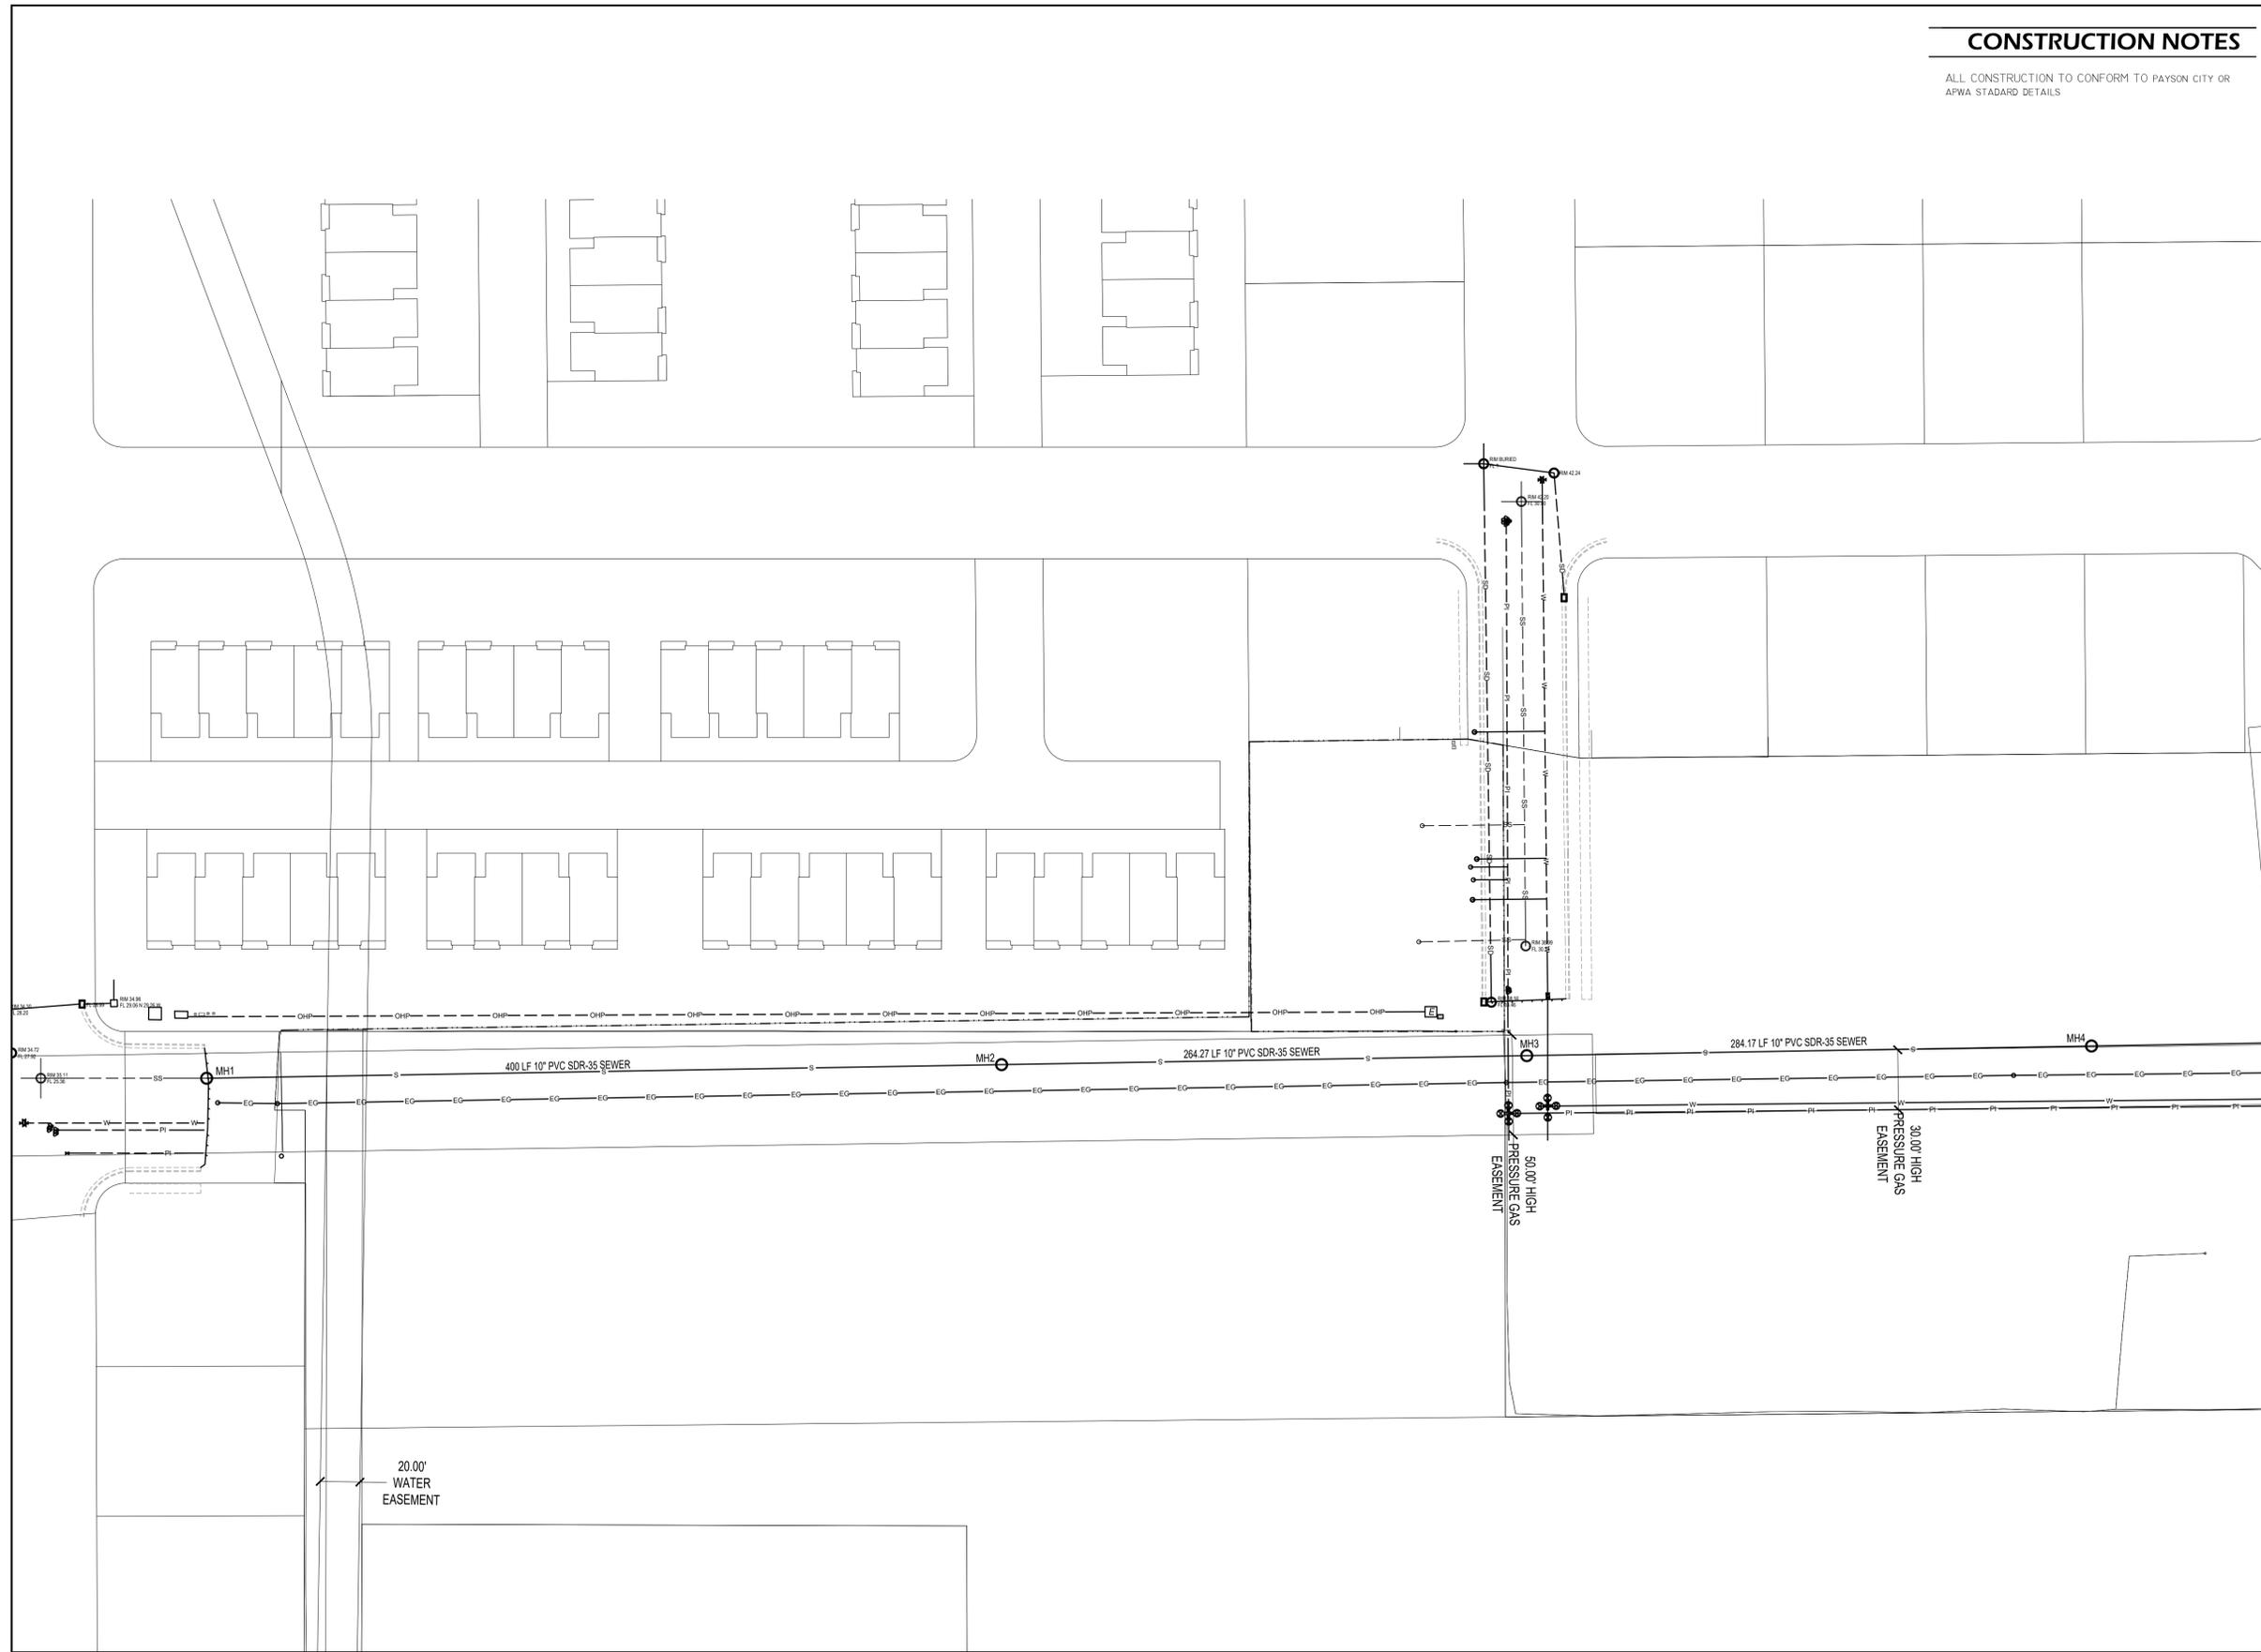
**PAYSON VIEW
ESTATES
PHASE 4**

DESCRIPTION

**PRELIMINARY
PLANS**

SHEET NAME SHEET NUMBER

SEWER C2.3



K:\Projects\2024\Payson View Estates Phase 4\Drawings\SEWER C2.3.dwg
 DATE: 01/16/2024
 KENNETH R. BERG P.E.
 SERIAL NO. 343602

CONSTRUCTION NOTES

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DEVELOPMENT

PAYSON VIEW ESTATES PHASE 4

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Highland, UT 84003
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0 20 40 80 120
SCALE: 1" = 40'



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PAYSON VIEW ESTATES PHASE 4

DESCRIPTION

PRELIMINARY PLANS

SHEET NAME SHEET NUMBER

POWER C2.4



NO PARKING FIRE LANE

ALL CUL-DE-SAC'S ARE REQUIRED TO BE RED CURBED AND SIGNED "NO PARKING FIRE LANE"

CONSTRUCTION NOTES

NO TRAFFIC CALMING DEVICES TO BE INSTALLED
FIRE FLOW TO MEET CITY STANDARDS OF 2000 GPM

CODE ANALYSIS

ZONE =	R-I-9 & R-I-12
TYPE OF BUILDING =	SINGLE FAMILY
TYPE OF OCCUPANCY =	R-3
FIRE SPRINKLED =	NO
TYPE OF CONSTRUCTION =	V-B
BUILDING HEIGHT =	28



DEVELOPMENT
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PROJECT
PAYSON VIEW ESTATES PHASE 4

DESCRIPTION
PRELIMINARY PLANS

SHEET NAME	SHEET NUMBER
FIRE C2.5	

RETENTION POND NOTES

1. RETENTION POND DESIGNED WITH THE CAPACITY TO CONTROL THE 100 YEAR-24 HOUR STORM EVENT
2. POND SIDE SLOPES OF 5:1
3. 1 FOOT FREEBOARD PROVIDED.
4. NO DISCHARGE INTO HIGH LINE CANAL IS ALLOWED.

LOT DRAINAGE

ALL LOTS TO CONTROL RUNOFF ON EACH LOT. NO LOT TO LOT DRAINAGE IS ALLOWED.
ALL LOTS REQUIRED TO HAVE FULL LANDSCAPE PRIOR TO OCCUPANCY.

CONSTRUCTION NOTES

ALL CONSTRUCTION TO CONFORM TO PAYSON CITY OR APWA STABARD DETAILS
A STORM WATER MANAGEMENT PLAN WILL BE REQUIRED PRIOR TO CONSTRUCTION

DRAINAGE CALCULATIONS

REFER TO SHEET C3.2 FOR STORM DRAINAGE CALCULATIONS FOR TEMPORARY POND

SURVEY CONTROL

SITE BENCHMARK
EAST QUARTER CORNER OF SEC. 20, T9S, R2E, SLB8M
B.M. ELEVATION = 4836.30
BASIS OF BEARING
N 89°35'10" E BETWEEN THE NORTHWEST AND NORTH QUARTER CORNERS OF SECTION 21, T9S, R2E, SLB8M



DEVELOPMENT
PAYSON VIEW ESTATES PHASE 4

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PROJECT
PAYSON VIEW ESTATES PHASE 4

DESCRIPTION
PRELIMINARY PLANS

SHEET NAME	SHEET NUMBER
GRADE C3.1	

RETENTION POND NOTES

- RETENTION POND DESIGNED WITH THE CAPACITY TO CONTROL THE 100 YEAR-24 HOUR STORM EVENT
- POND SIDE SLOPES OF 5:1
- 1 FOOT FREEBOARD PROVIDED.
- NO DISCHARGE INTO HIGH LINE CANAL IS ALLOWED.

LOT DRAINAGE

ALL LOTS TO CONTROL RUNOFF ON EACH LOT. NO LOT TO LOT DRAINAGE IS ALLOWED.
ALL LOTS REQUIRED TO HAVE FULL LANDSCAPE PRIOR TO OCCUPANCY.

CONSTRUCTION NOTES


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A STORM WATER MANAGEMENT PLAN WILL BE REQUIRED PRIOR TO CONSTRUCTION

DRAINAGE CALCULATIONS

REFER TO SHEET C3.2 FOR STORM DRAINAGE CALCULATIONS FOR TEMPORARY POND

SURVEY CONTROL

SITE BENCHMARK
EAST QUARTER CORNER OF SEC 20,T9S, R2E, SLB8M
B.M. ELEVATION = 4836.30
BASIS OF BEARING
N 89°35'10" E BETWEEN THE NORTHWEST AND NORTH QUARTER CORNERS OF SECTION 21,T9S, R2E, SLB8M

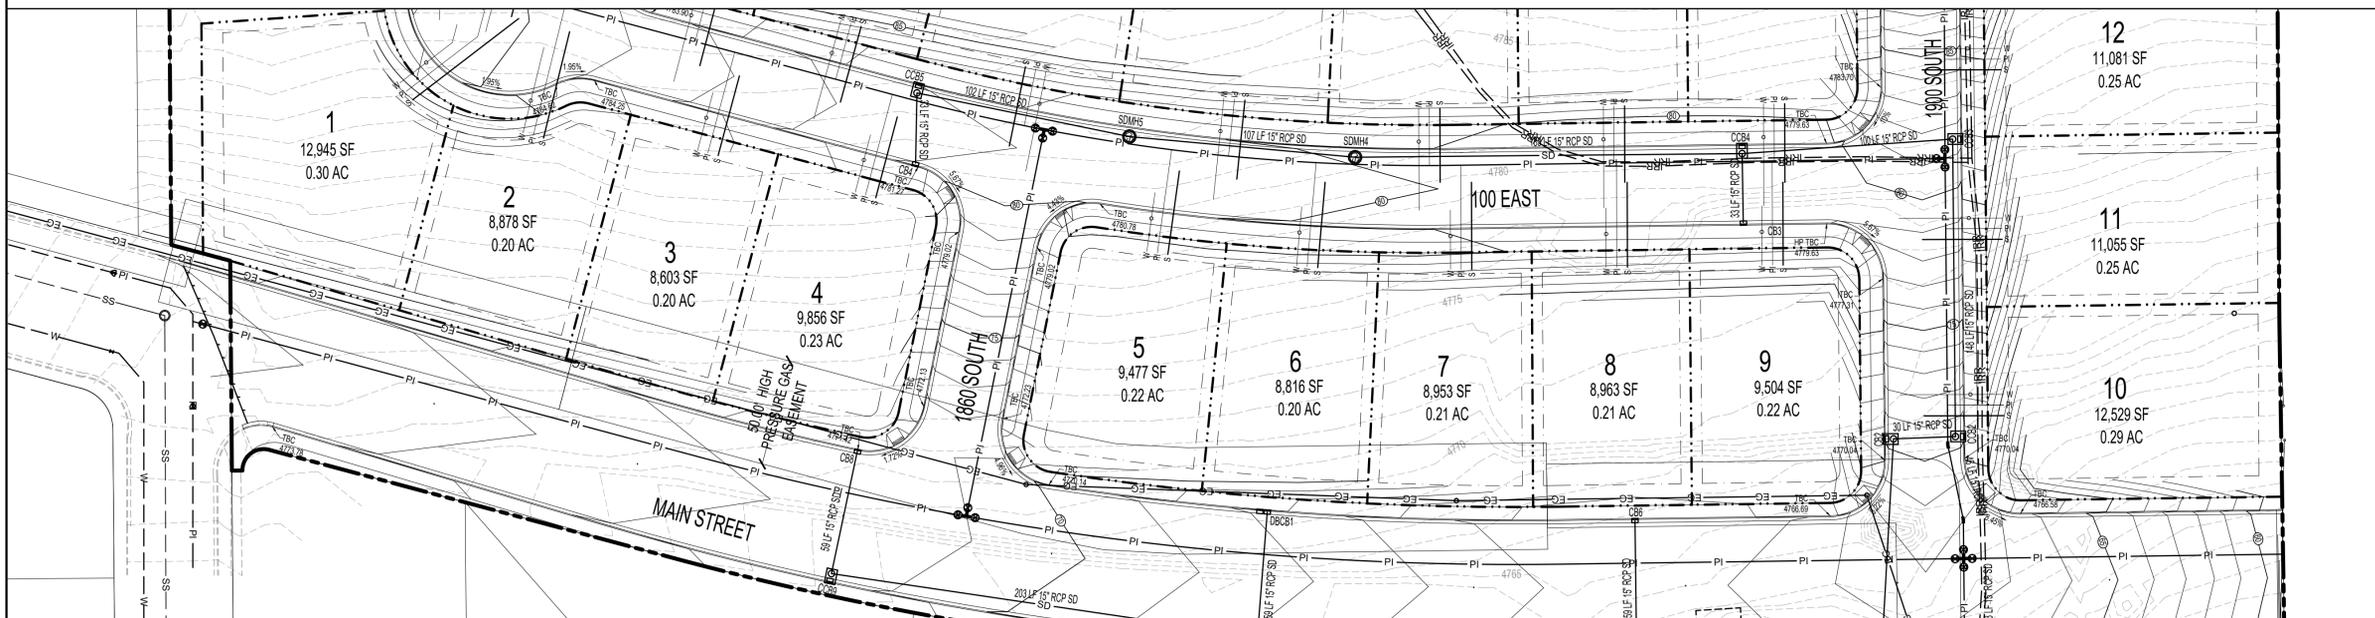

**PAYSON VIEW ESTATES - PHASE 4
100-Y RETENTION
TEMP POND**

Storm drain calculations were performed using the rational method.



Hydrologic Calculations CA CALCULATION			
	C	Area (ft ²)	C * A
Overall			
Lot Landscape	0.10	230989	23099
Roadways	0.90	149028	134125
Homes	0.85	39600	33660
Totals		419617	190884
Contributing Acres:	9.63		
Infiltration Rate	0.50 in/hr		
Pond Bottom Area	13000 sf		
Q _{allow} Discharge of Perc. Rate for pond bottom	0.15 cfs		
Total Outflow	0.15 cfs		

POND RATING TABLE RETENTION POND / DETENTION POND					
	ELEV (ft)	AREA (sf)	INCR (cf)	TOTAL (cf)	
Overall					
4754	18105	16743	42499		
4755	21003	19554	62053		
100 Y HW			4753.50		

Retention Pond Volume calculations					
Lapsed Time (min.)	Rainfall intensity (in/hr)	Total Rainfall (in)	Rainfall Volume (ft ³)	Release Volume (ft ³)	Required Storage (ft ³)
A	B	C	D	E	F
5	6.42	0.58	9191	49	9142
10	4.89	0.82	12964	90	12874
15	4.04	1.01	16066	135	15931
30	2.72	1.36	21634	271	21363
60	1.68	1.68	26724	542	26182
120	0.94	1.88	29905	1083	28822
180	0.65	1.95	31019	1625	29394
360	0.35	2.10	33405	3250	30155
1440	0.12	2.68	45812	13000	32812
Time to infiltrate Pond Max	29394 ft³		57.27 hrs total		


Required Pond Volume =	32812 ft ³	or	0.753 acre-ft
TEMP POND VOLUME	62053 ft ³	or	1.425 acre-ft

Notes:
A, B, & C are based upon NOAA ATLAS
D = C / (12 inches/foot) x total acreage of site x run-off coefficient, where Q=CIA and V=CIA
F = D - E to determine storage volume

DEVELOPMENT
**PAYSON
VIEW
ESTATES
PHASE 4**

DEVELOPER

11038 N. Highland Blvd Suite 100
Highland, UT 84003
(801) 642-0119

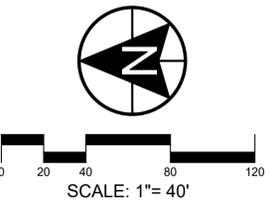

1018 N. Deer Crest Lane
Alpine, UT, 84004
office (801) 492-1277
cell (801) 616-1677


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ACTION: PRELIM DATE: 01/16/2024

PROJECT
**PAYSON VIEW
ESTATES
PHASE 4**

DESCRIPTION
**PRELIMINARY
PLANS**

SHEET NAME: **GRADE C3.2** SHEET NUMBER:

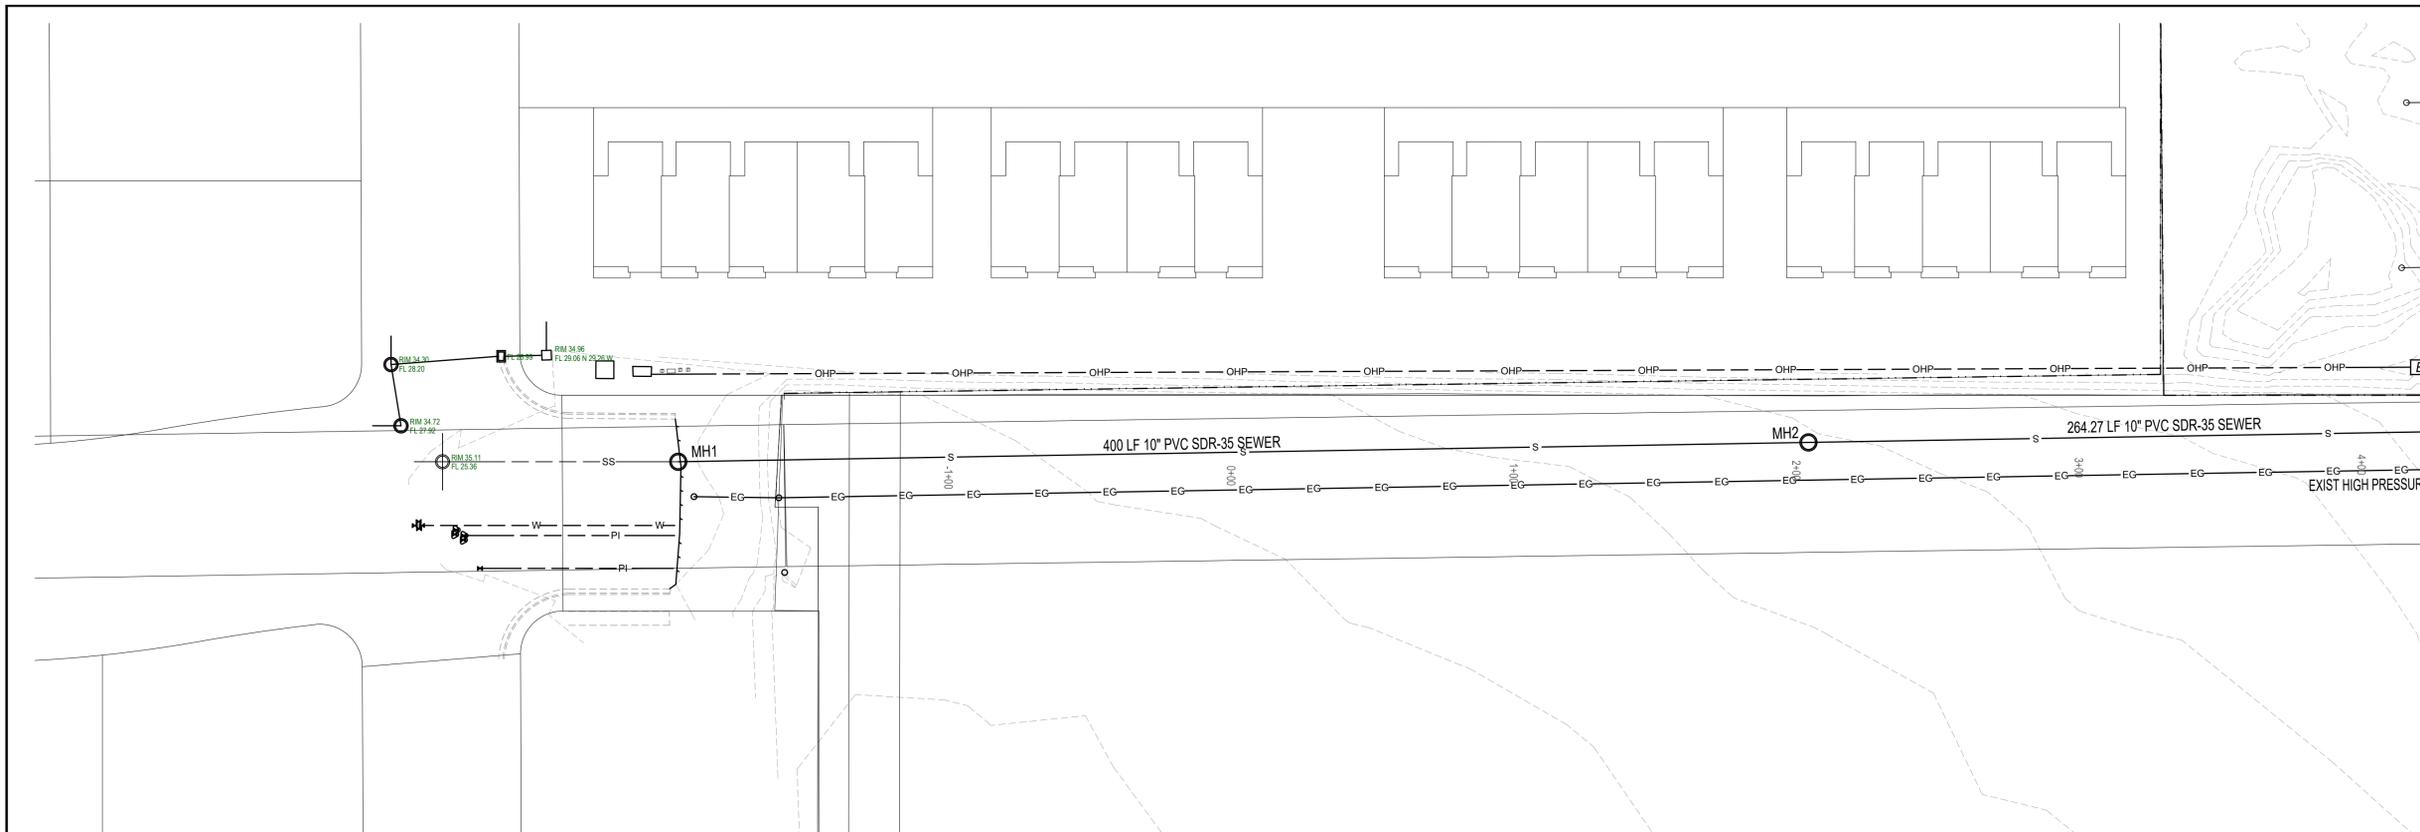

CONSTRUCTION NOTES

ALL CONSTRUCTION TO CONFORM TO
PAYSON CITY OR APWA STANDARD DETAILS

A STORM WATER MANAGEMENT PLAN
WILL BE REQUIRED PRIOR TO
CONSTRUCTION


DRAINAGE CALCULATIONS

REFER TO SHEET C3.2 FOR STORM
DRAINAGE CALCULATIONS FOR
TEMPORARY POND

SURVEY CONTROL

SITE BENCHMARK
EAST QUARTER CORNER OF SEC. 20, T9S, R2E, SLB8M
B.M. ELEVATION = 4836.30

BASIS OF BEARING
N 89°35'10" E BETWEEN THE NORTHWEST AND
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DEVELOPMENT

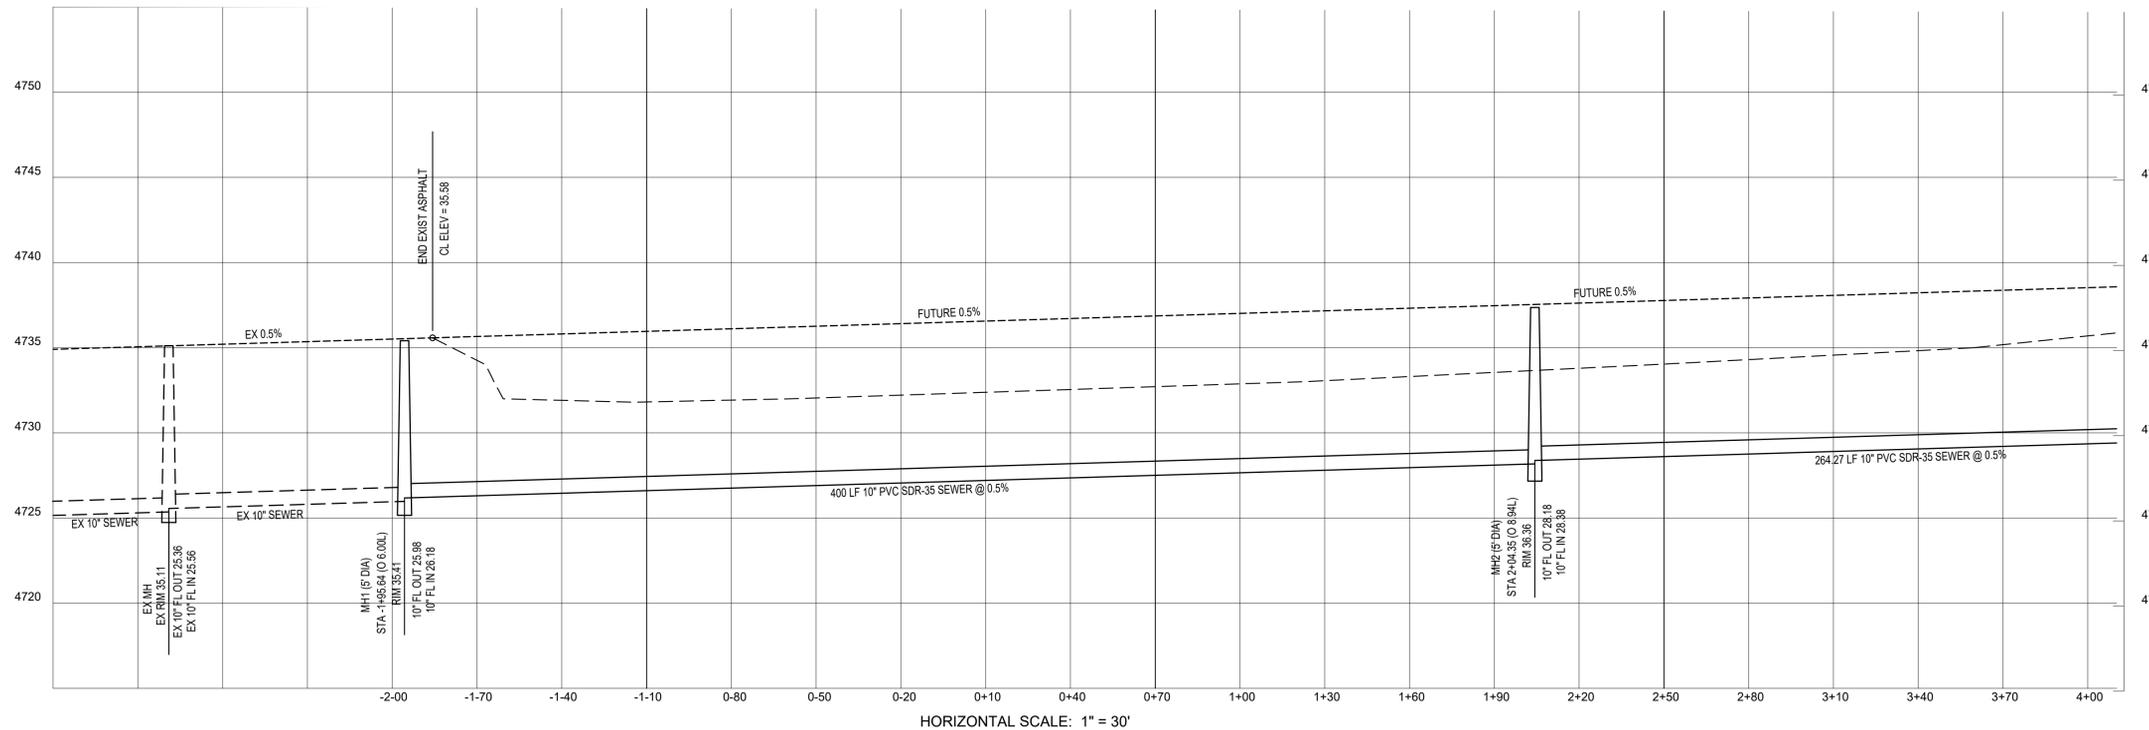
PAYSON VIEW ESTATES PHASE 4

DEVELOPER



PATTERSON HOMES
www.pnutah.com

11038 N. Highland Blvd Suite 100
Highland, UT 84003
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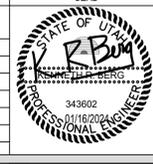


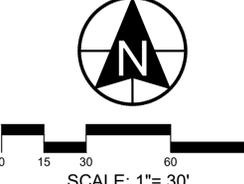SCALE: 1" = 30'



BERG CIVIL ENGINEERING

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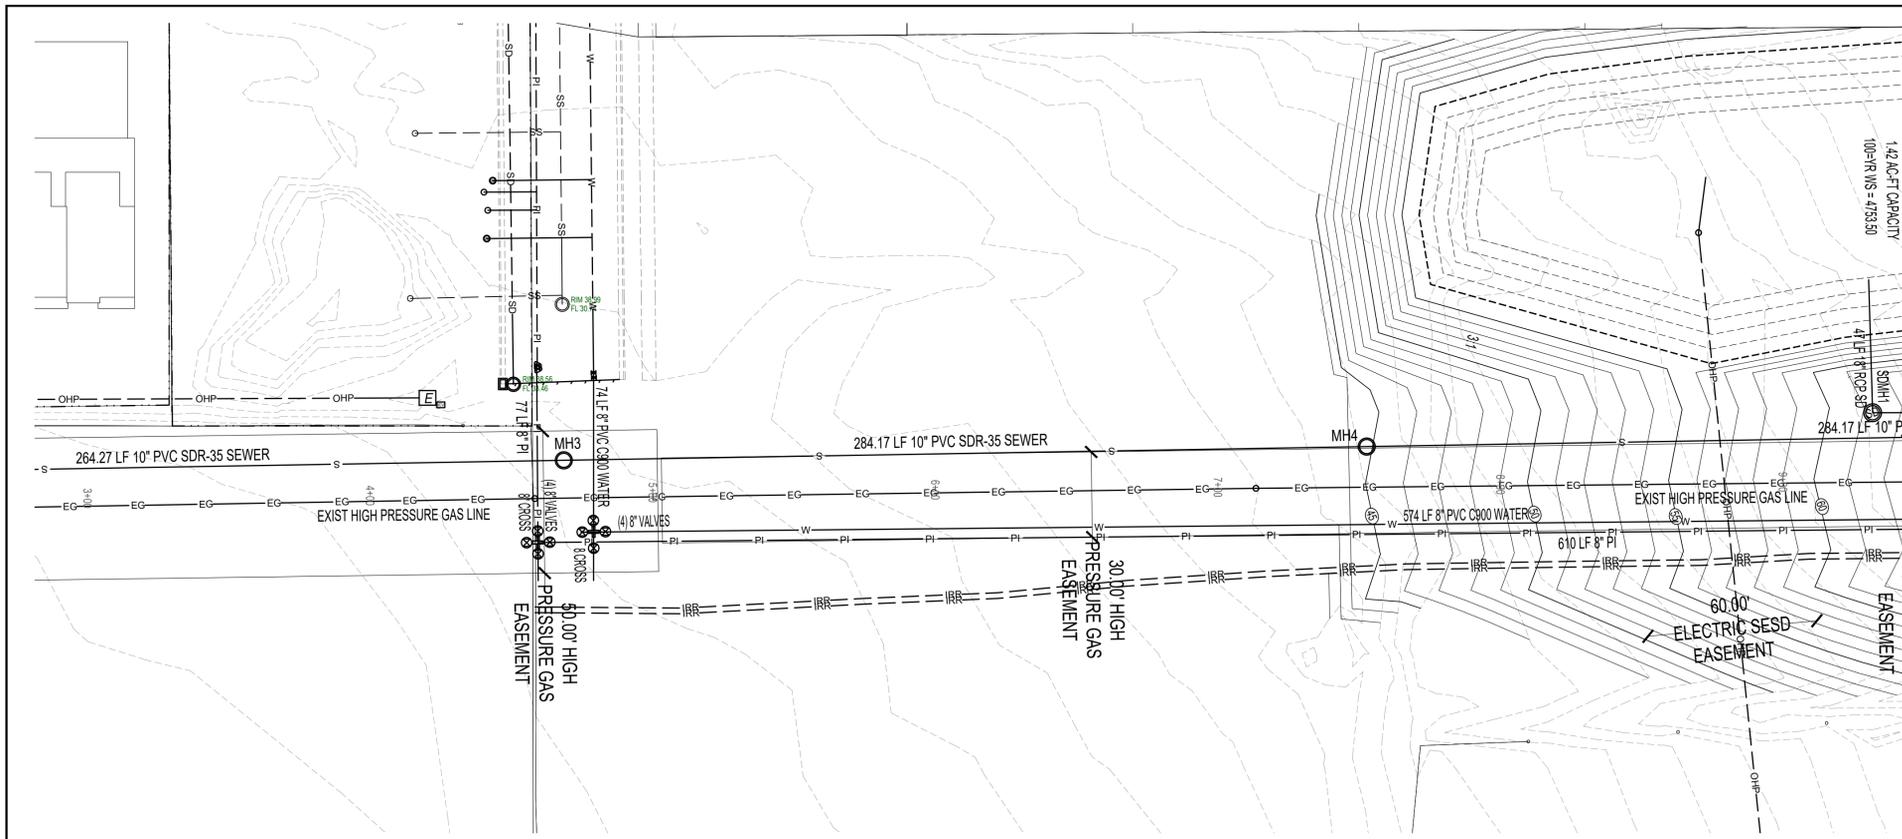
PAYSON VIEW ESTATES PHASE 4

DESCRIPTION

PRELIMINARY PLANS

SHEET NAME SHEET NUMBER

1900 S **C4.1**



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DRAINAGE CALCULATIONS

REFER TO SHEET C.3.2 FOR STORM DRAINAGE CALCULATIONS FOR TEMPORARY POND

SURVEY CONTROL

SITE BENCHMARK
EAST QUARTER CORNER OF SEC 20, T9S, R2E, SLB8M
B.M. ELEVATION = 4836.30

BASIS OF BEARING
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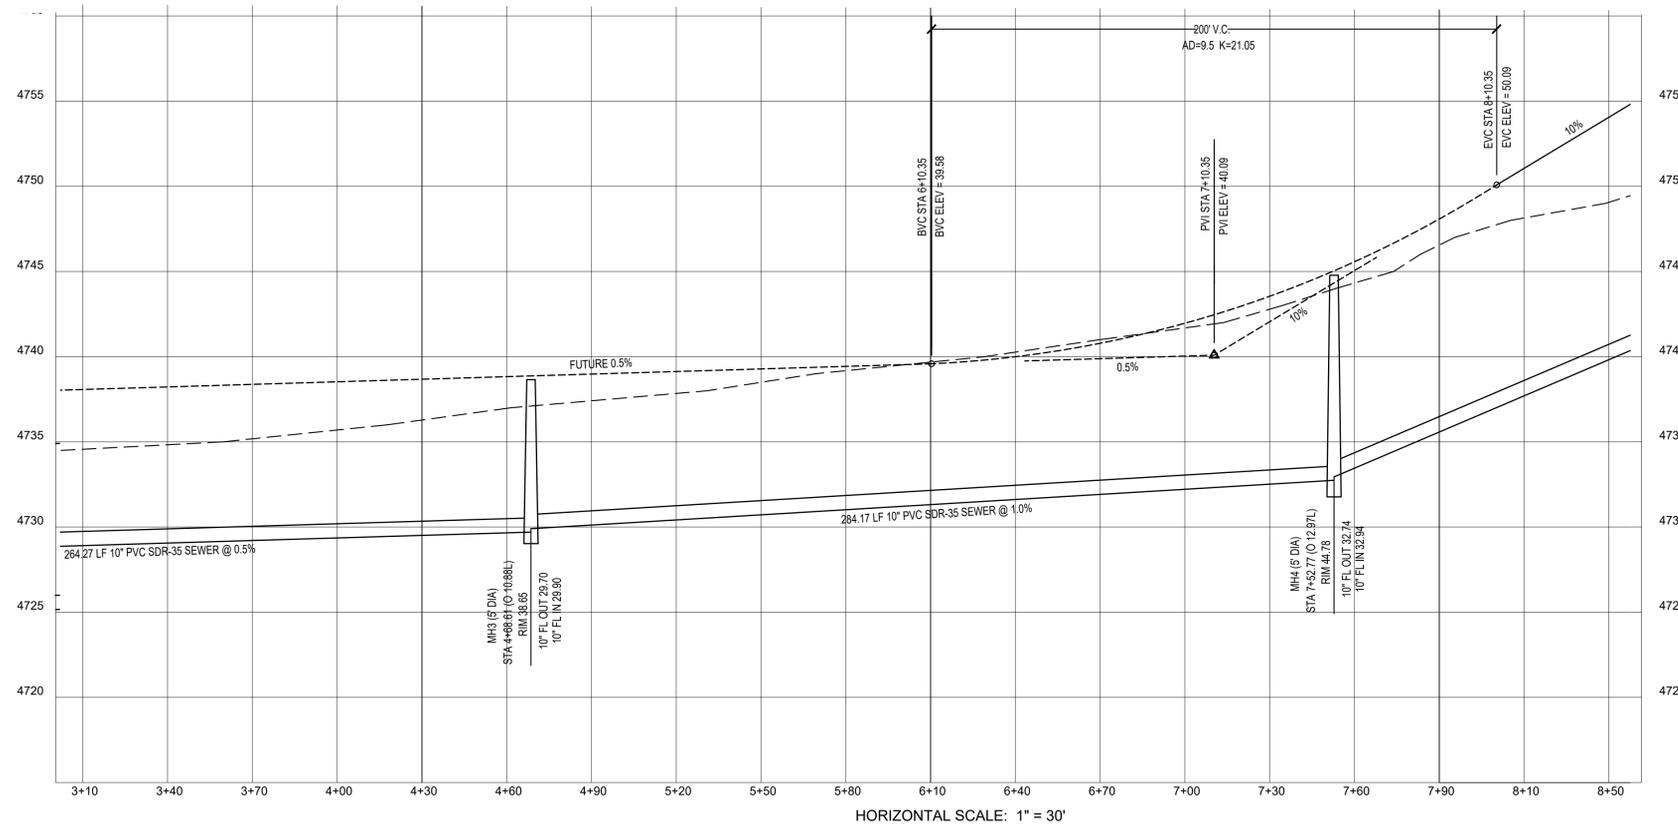
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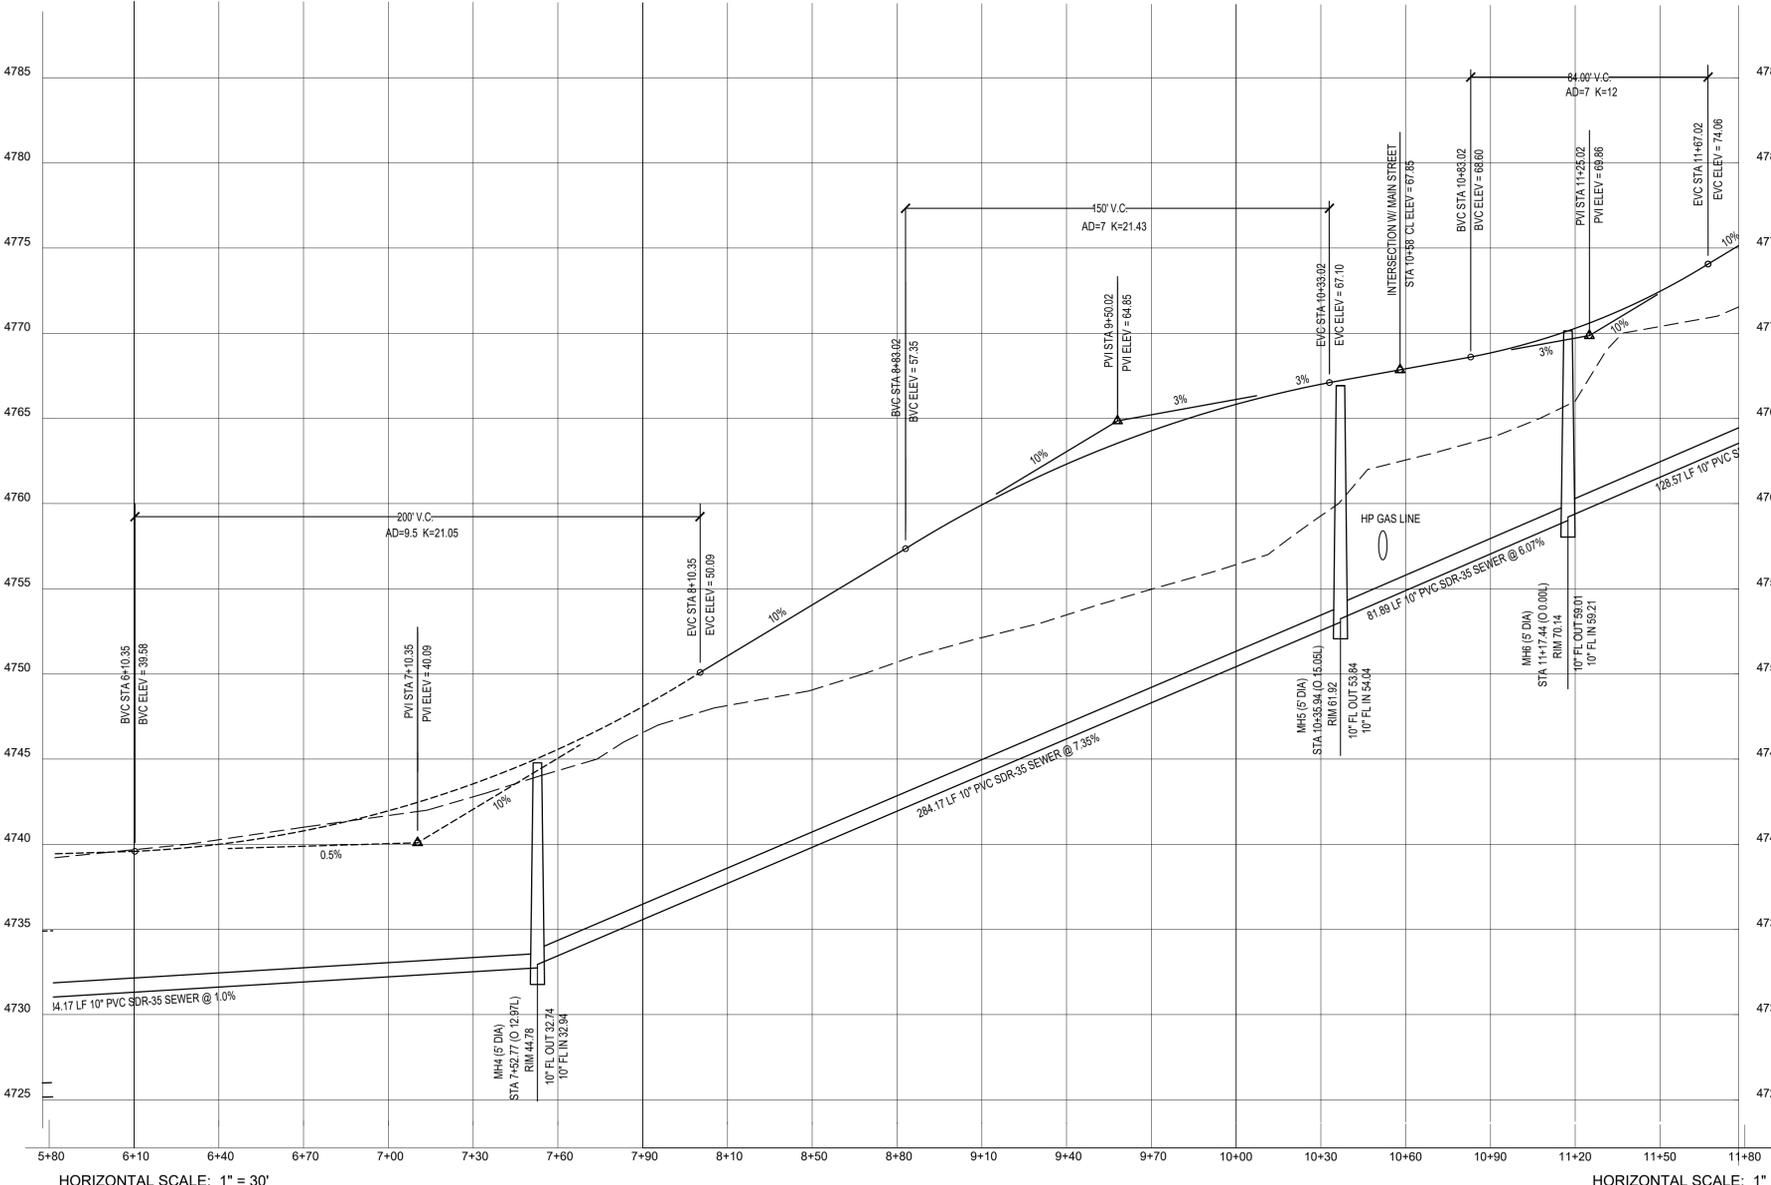
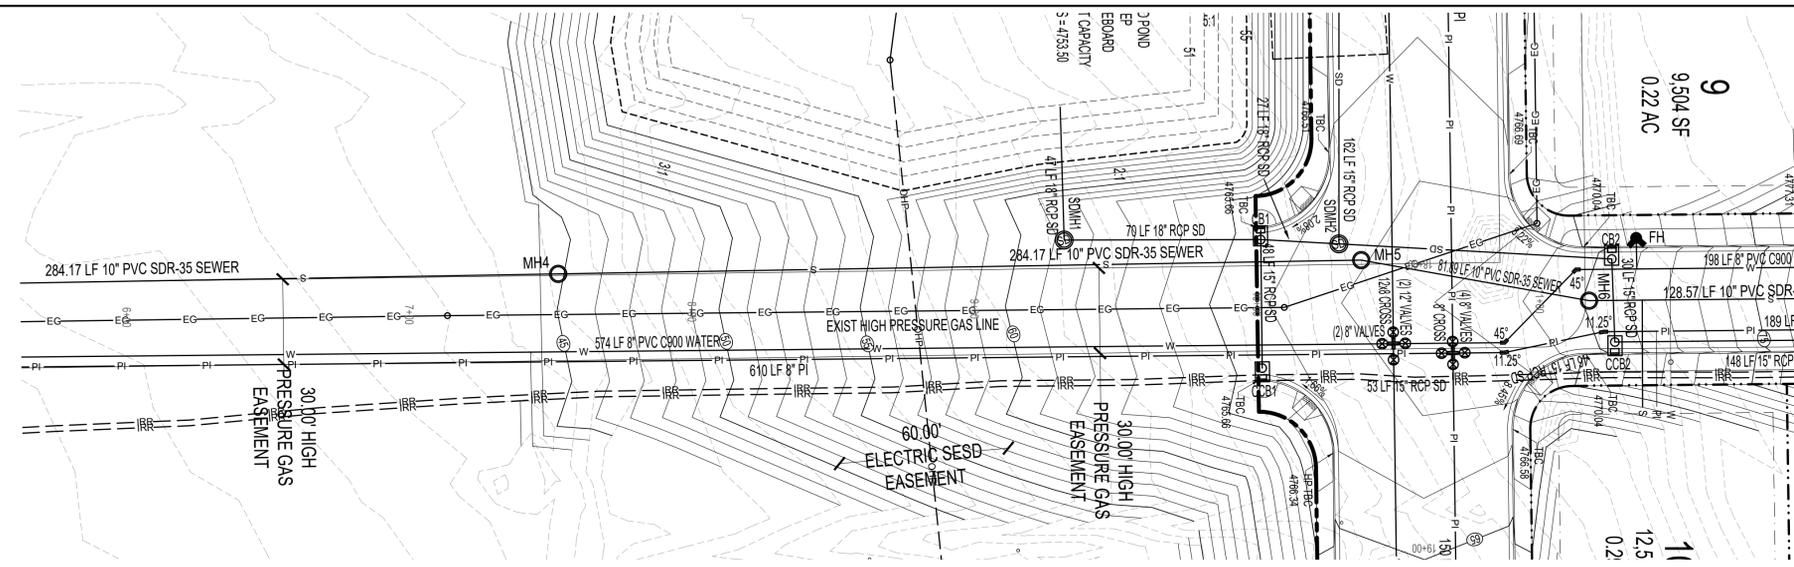
PROJECT
PAYSON VIEW ESTATES PHASE 4

DESCRIPTION
PRELIMINARY PLANS

SHEET NAME	SHEET NUMBER
1900 S	C4.2



1900 S C4.2 PRELIMINARY PLANS 01/16/2024



HORIZONTAL SCALE: 1" = 30'

HORIZONTAL SCALE: 1"

CONSTRUCTION NOTES

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DRAINAGE CALCULATIONS

REFER TO SHEET C3.2 FOR STORM DRAINAGE CALCULATIONS FOR TEMPORARY POND

SURVEY CONTROL

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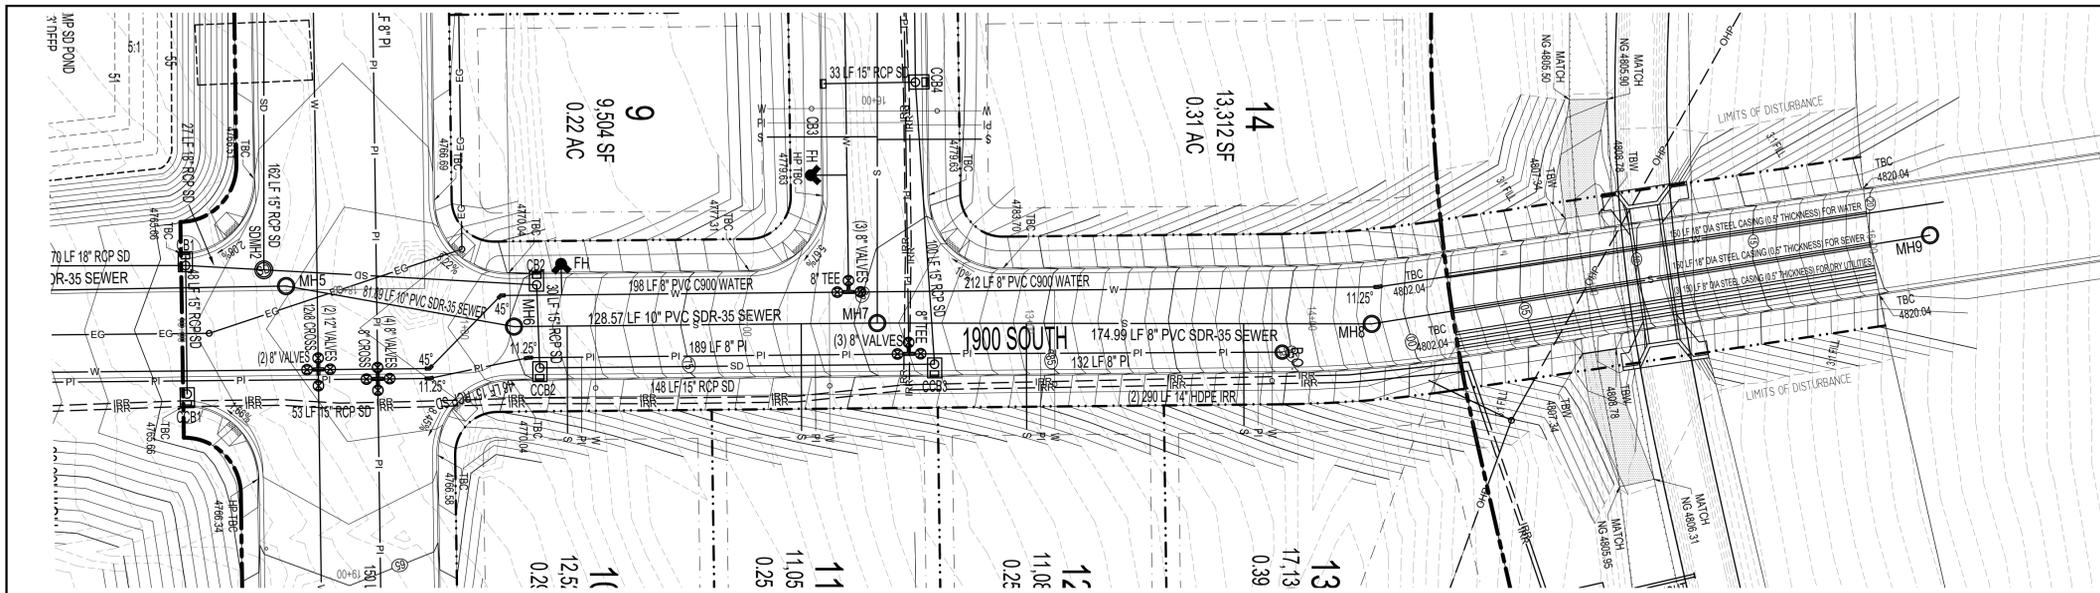
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PROJECT
PAYSON VIEW ESTATES PHASE 4

DESCRIPTION
PRELIMINARY PLANS

SHEET NAME	SHEET NUMBER
1900 S	C4.3



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SURVEY CONTROL
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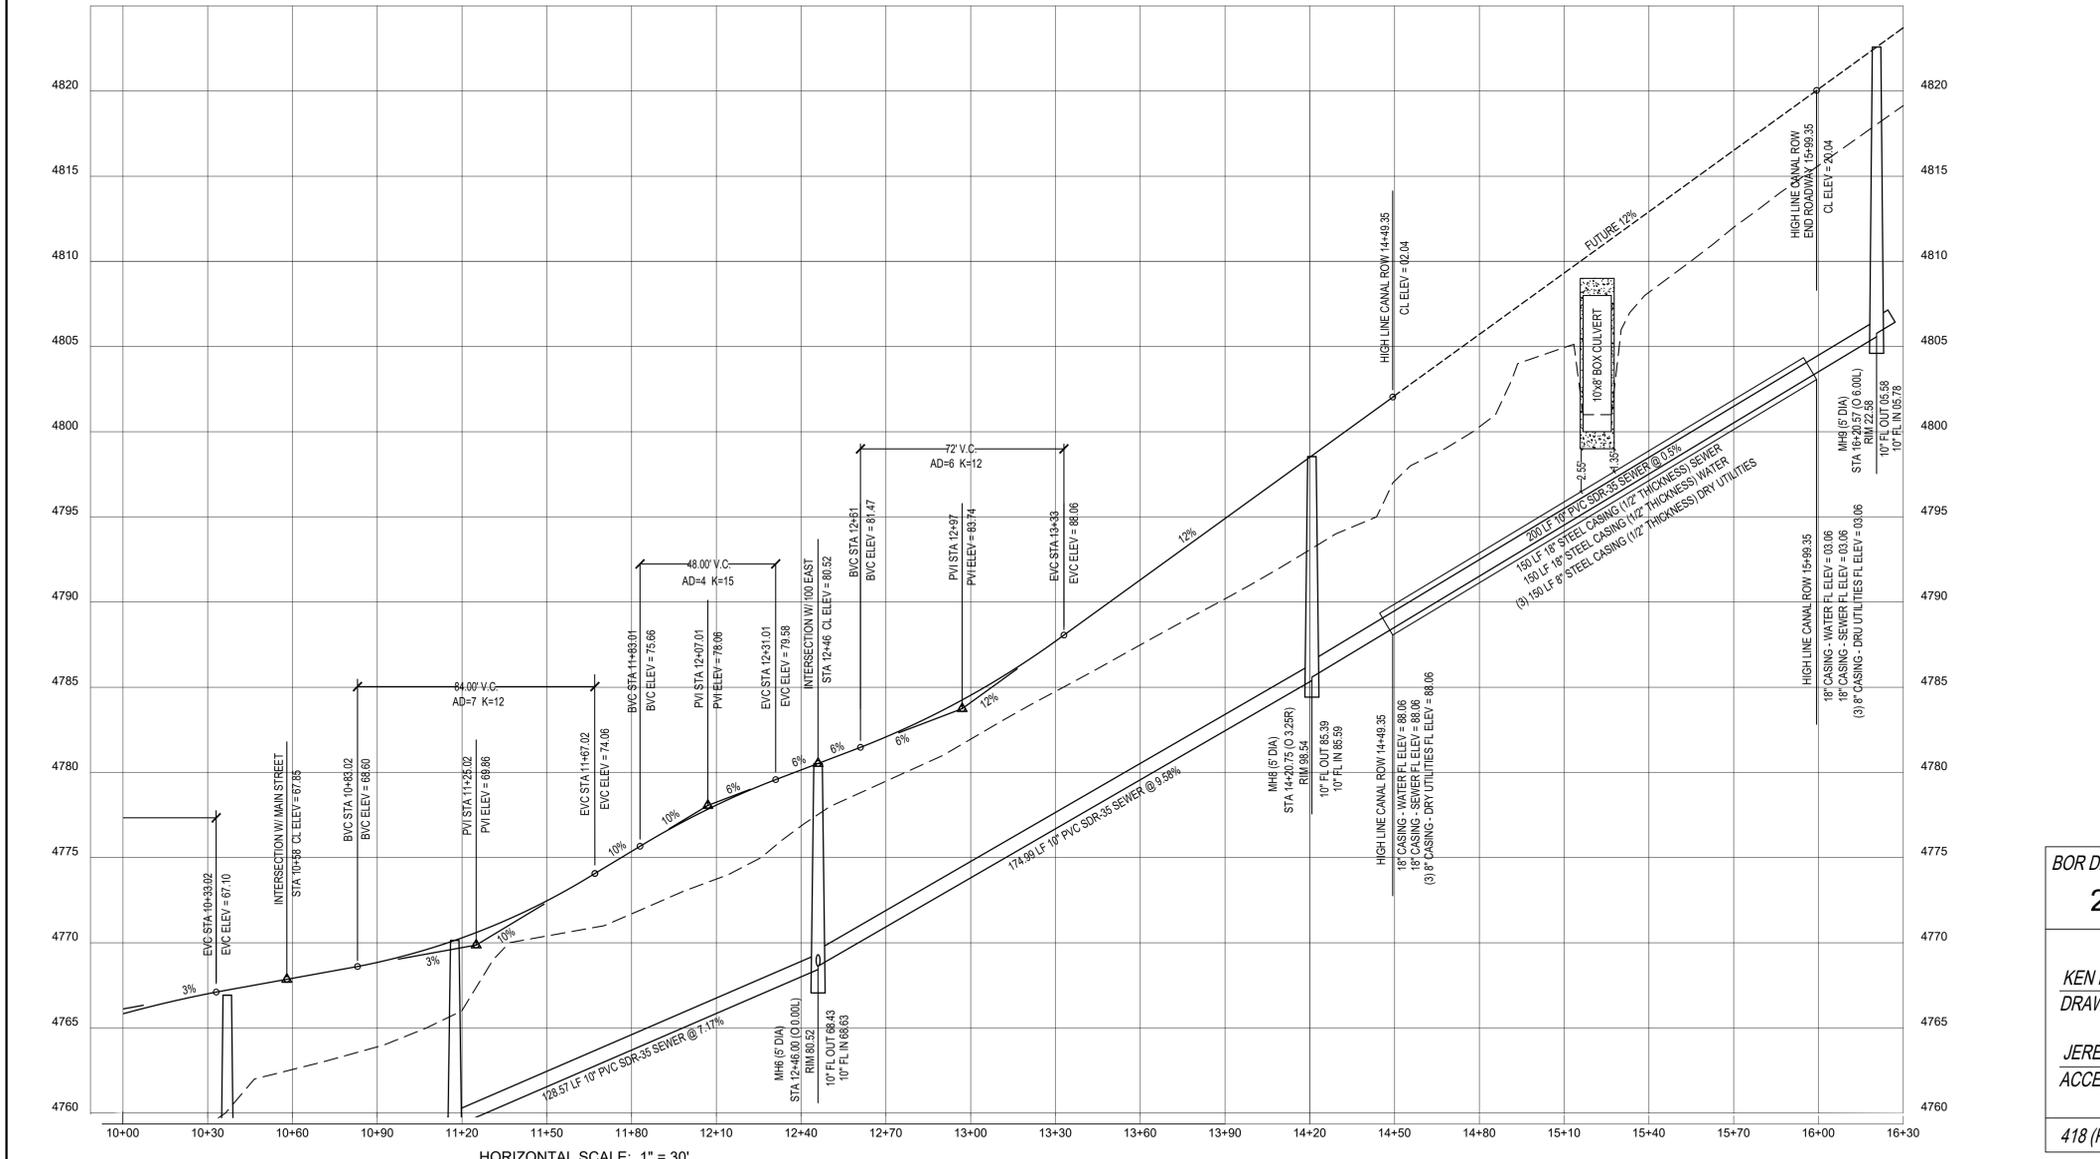
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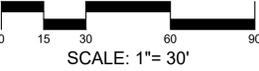
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DISTURBED AREA
 TOTAL AREA OF DISTURBANCE WITHIN THE CANAL RIGHT-OF-WAY = 0.36 AC

SCALE: 1" = 30'



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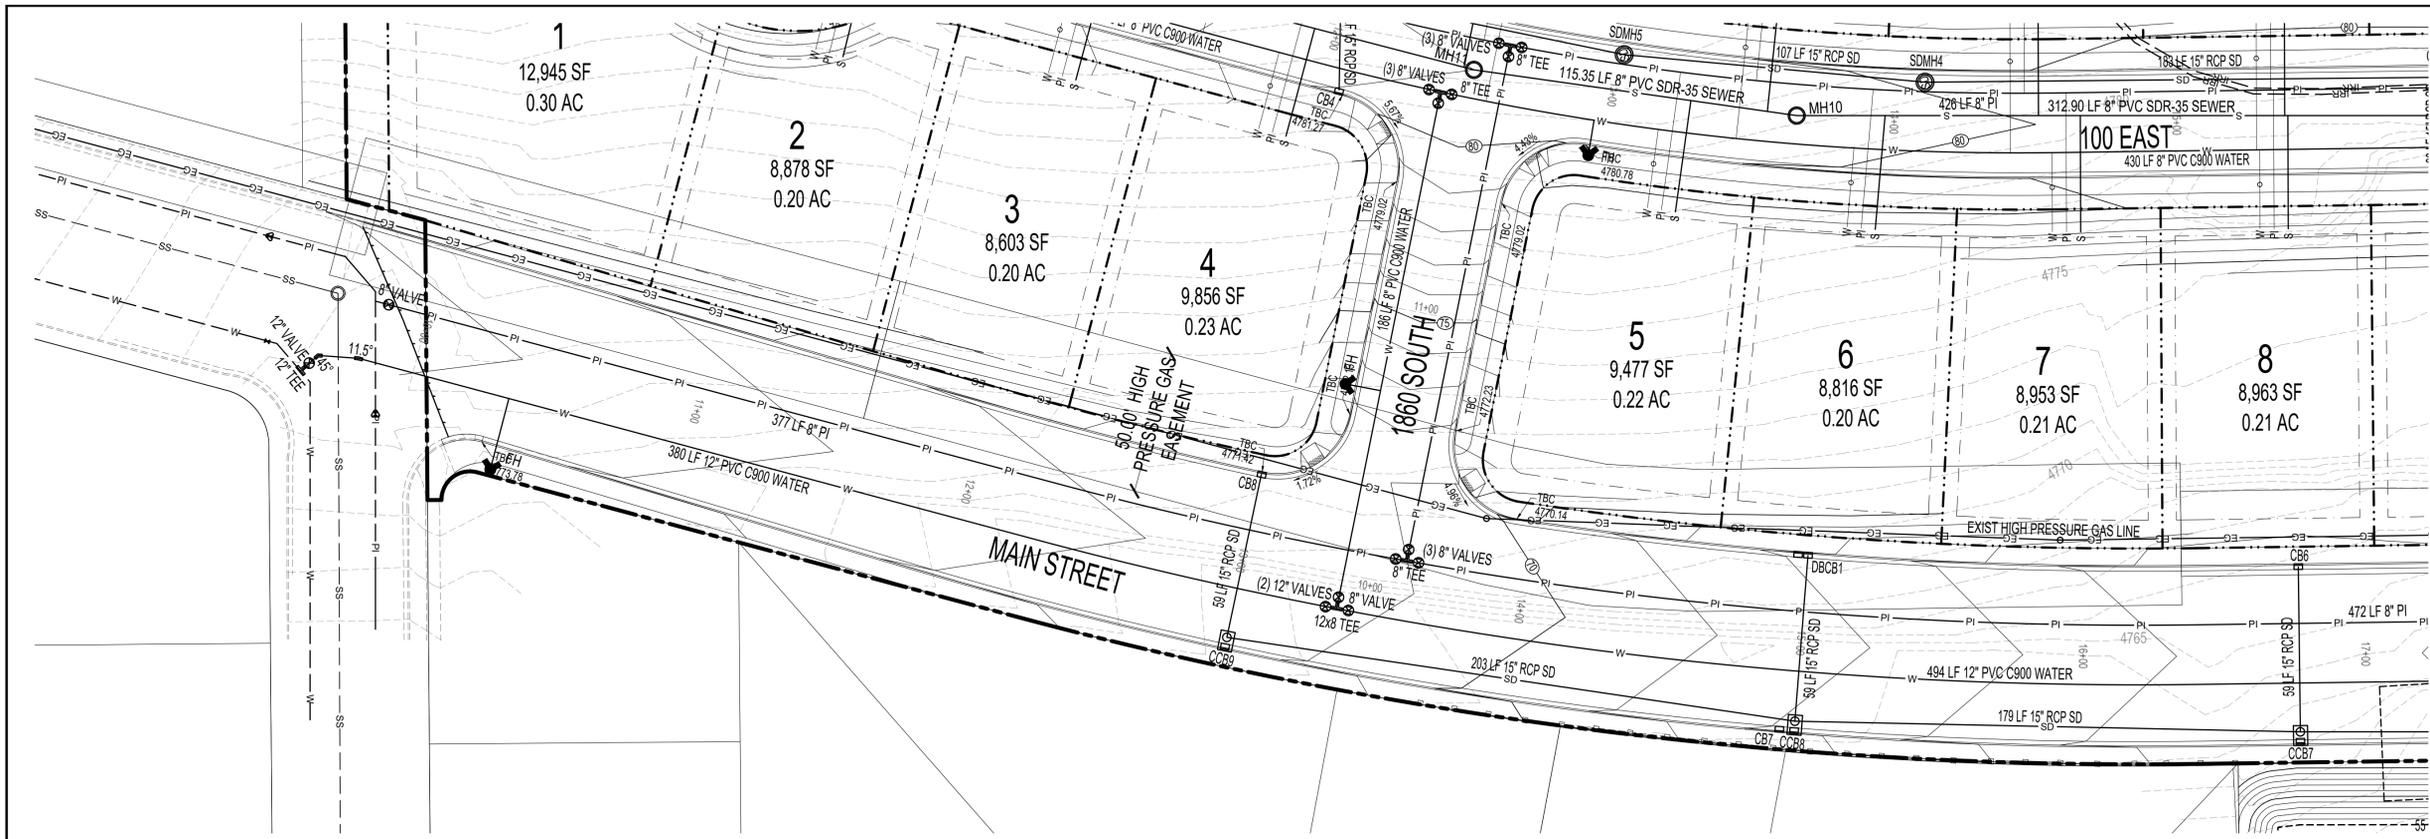
SHEET NAME	SHEET NUMBER
1900 S	C4.4

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KEN R. BERG, P.E.
 DRAWN

JEREMY FOWLER, P.E.
 ACCEPTED

418 (PROVO, UT) 2023-11-08



CONSTRUCTION NOTES

ALL CONSTRUCTION TO CONFORM TO PAYSON CITY OR APWA STANDARD DETAILS

A STORM WATER MANAGEMENT PLAN WILL BE REQUIRED PRIOR TO CONSTRUCTION

DRAINAGE CALCULATIONS


REFER TO SHEET C5.2 FOR STORM DRAINAGE CALCULATIONS FOR TEMPORARY POND

SURVEY CONTROL

SITE BENCHMARK EAST QUARTER CORNER OF SEC. 20, T9S, R2E, SLB8M B.M. ELEVATION = 4836.50

BASIS OF BEARING N 89°35'10" E BETWEEN THE NORTHWEST AND NORTH QUARTER CORNERS OF SECTION 20, T9S, R2E, SLB8M

MAIN STREET

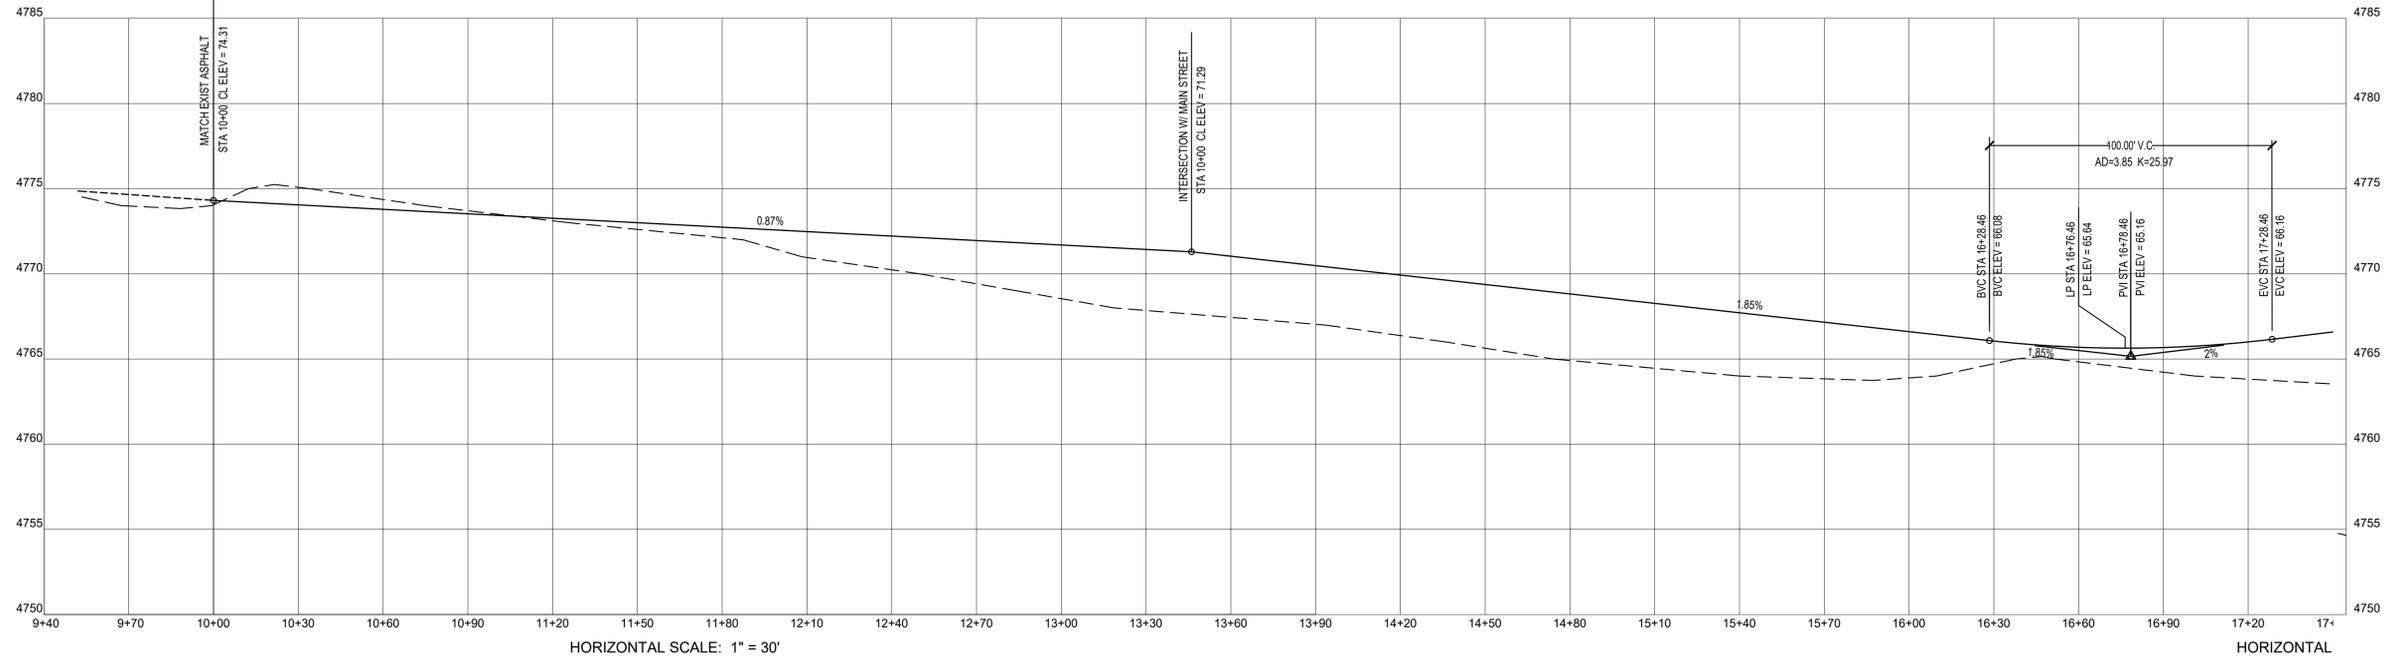

DEVELOPMENT
PAYSON VIEW ESTATES PHASE 4

DEVELOPER

11038 N. Highland Blvd Suite 100
Highland, UT 84003
(801) 642-0119

SCALE: 1" = 30'

1018 N. Deer Crest Lane
Alpine, UT, 84004
office (801) 492-1277
cell (801) 616-1677


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ACTION	DATE
PRELIM	01/16/2024

PROJECT
PAYSON VIEW ESTATES PHASE 4

DESCRIPTION
PRELIMINARY PLANS

SHEET NAME	SHEET NUMBER
MAIN	C5.1

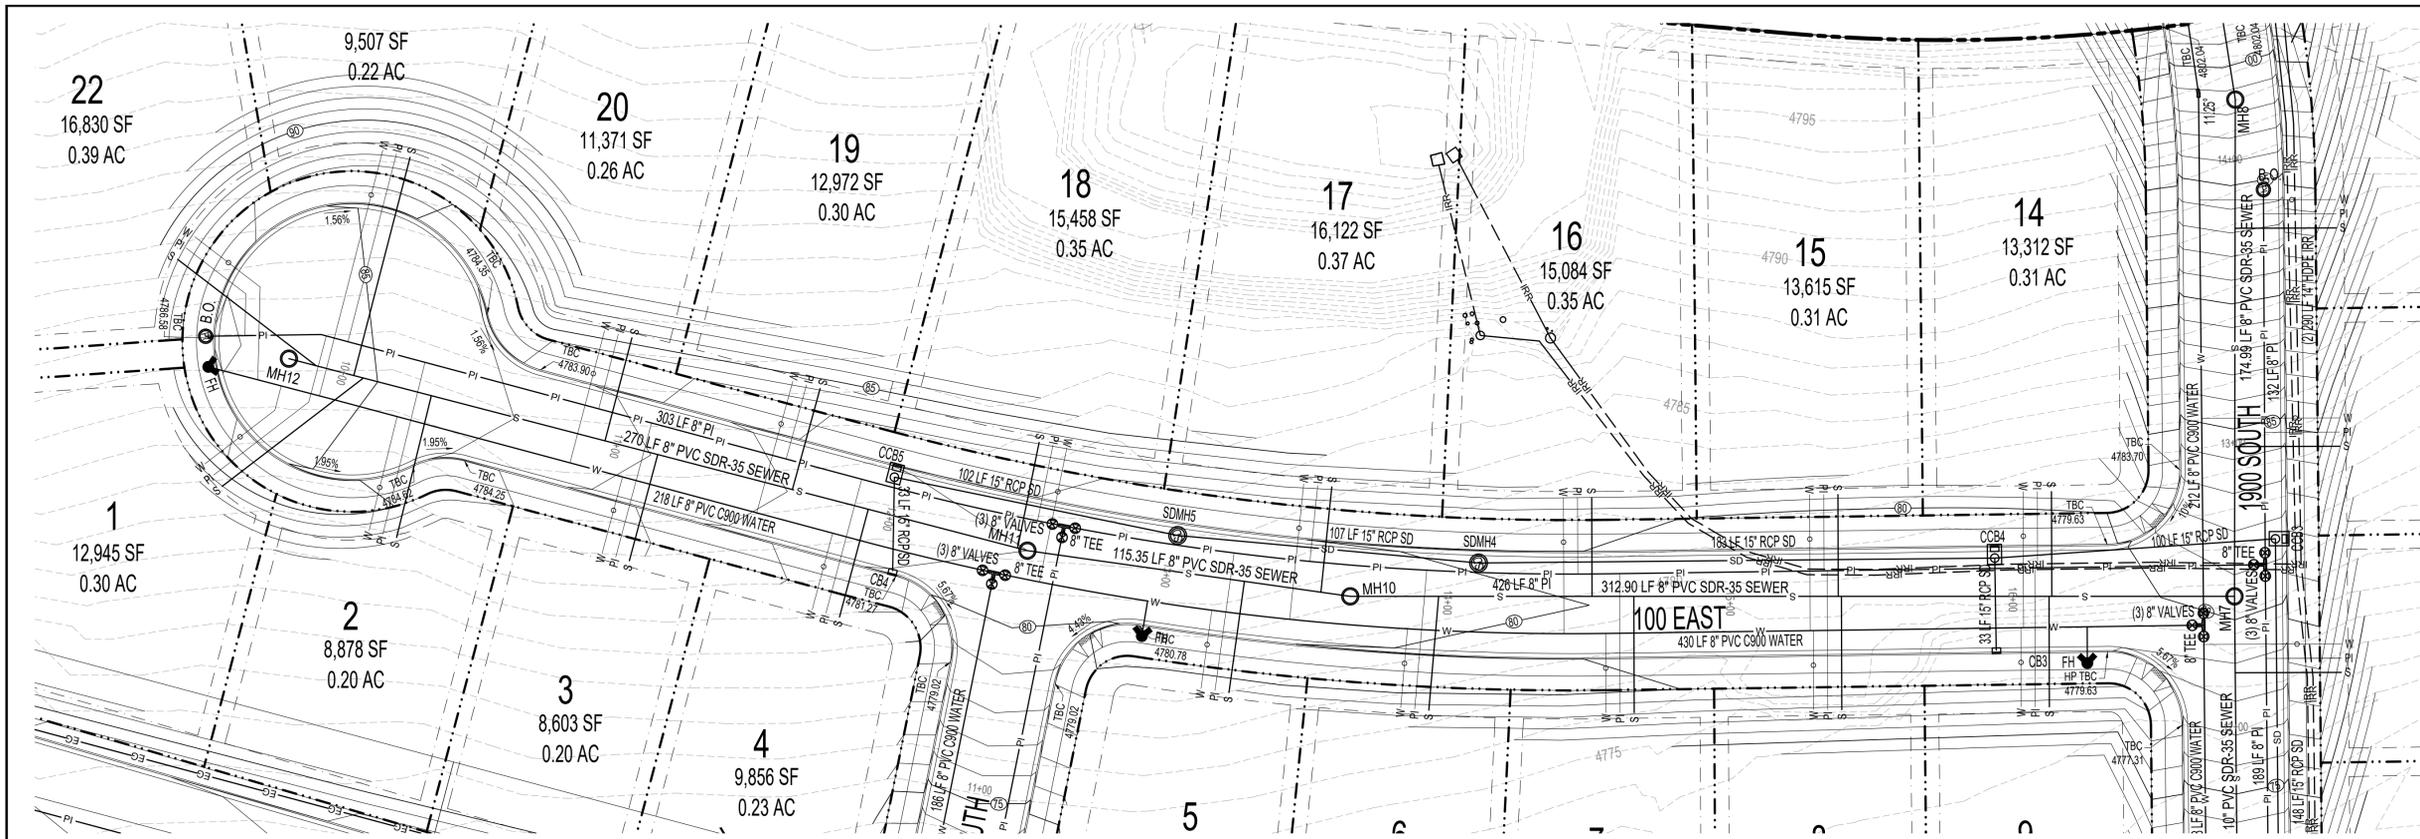

CONSTRUCTION NOTES

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DRAINAGE CALCULATIONS


REFER TO SHEET C3.2 FOR STORM DRAINAGE CALCULATIONS FOR TEMPORARY POND

SURVEY CONTROL

SITE BENCHMARK
EAST QUARTER CORNER OF SEC 20, T9S, R2E, SLB8M
B.M. ELEVATION = 4836.50

BASIS OF BEARING
N 89°35'10" E BETWEEN THE NORTHWEST AND NORTH QUARTER CORNERS OF SECTION 20, T9S, R2E, SLB8M


100 EAST

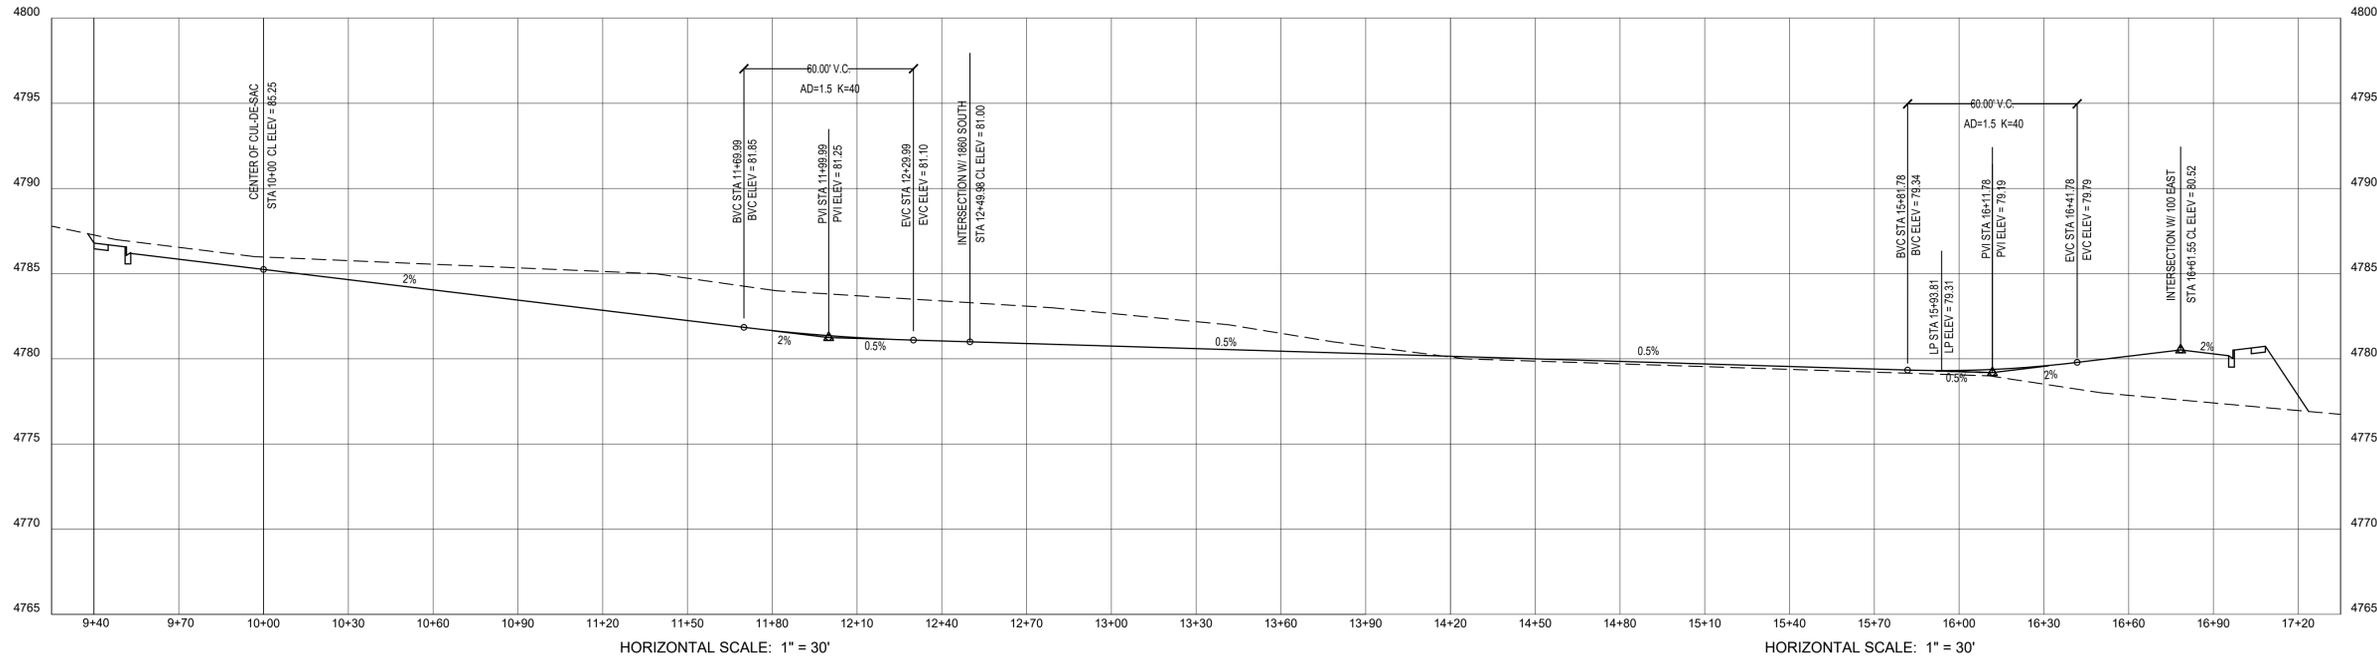

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DEVELOPER

11038 N. Highland Blvd Suite 100
Highland, UT 84003
(801) 642-0119

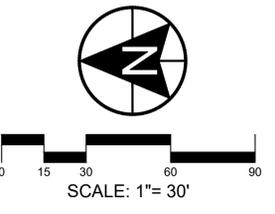

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Alpine UT, 84004
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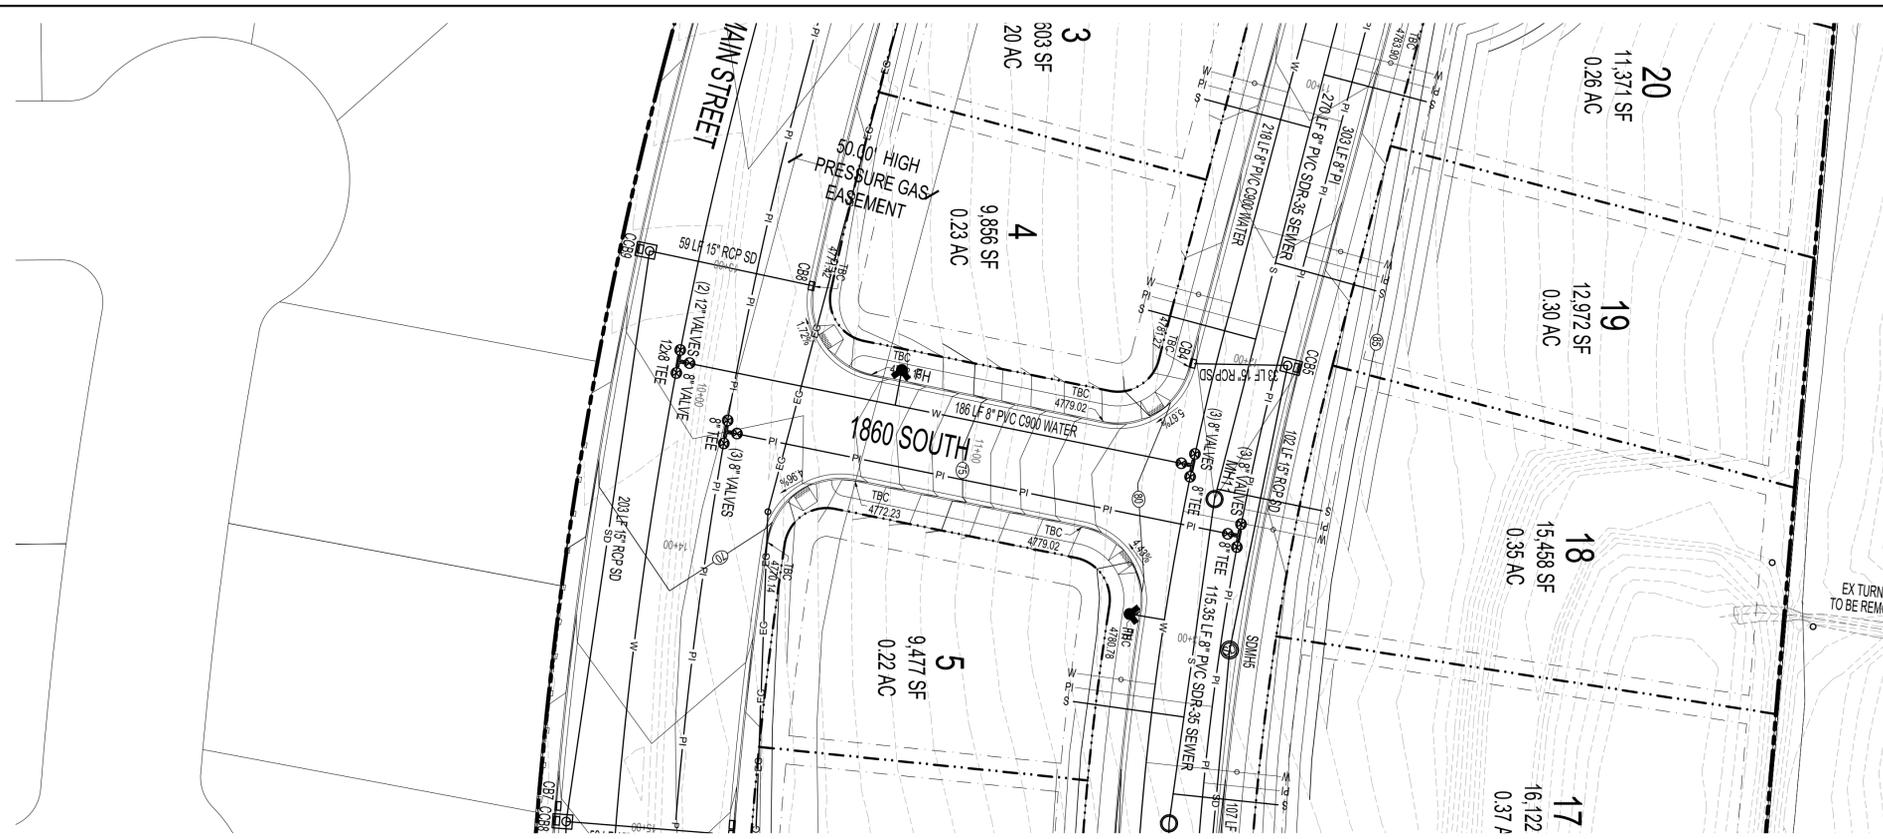
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ACTION	DATE
PRELIM	01/16/2024

PROJECT
PAYSON VIEW ESTATES PHASE 4

DESCRIPTION
PRELIMINARY PLANS

SHEET NAME	SHEET NUMBER
100 E	C6.1



CONSTRUCTION NOTES

ALL CONSTRUCTION TO CONFORM TO PAYSON CITY OR APWA STANDARD DETAILS

A STORM WATER MANAGEMENT PLAN WILL BE REQUIRED PRIOR TO CONSTRUCTION

DRAINAGE CALCULATIONS

REFER TO SHEET C3.2 FOR STORM DRAINAGE CALCULATIONS FOR TEMPORARY POND

SURVEY CONTROL

SITE BENCHMARK
EAST QUARTER CORNER OF SEC 20,T9S,R2E, SLB8M
B.M. ELEVATION - 4836.30

BASIS OF BEARING
N 89°35'10" E BETWEEN THE NORTHWEST AND NORTH QUARTER CORNERS OF SECTION 21,T9S,R2E, SLB8M


DEVELOPMENT

PAYSON VIEW ESTATES PHASE 4

DEVELOPER



11038 N. Highland Blvd Suite 100
Highland, UT 84003
(801) 642-0119

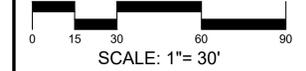

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Alpine, UT, 84004
office (801) 492-1277
cell (801) 616-1677

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PRELIM	01/16/2024

PROJECT


PAYSON VIEW ESTATES PHASE 4

DESCRIPTION

PRELIMINARY PLANS

SHEET NAME	SHEET NUMBER
1860 S	C7.1

1860 SOUTH

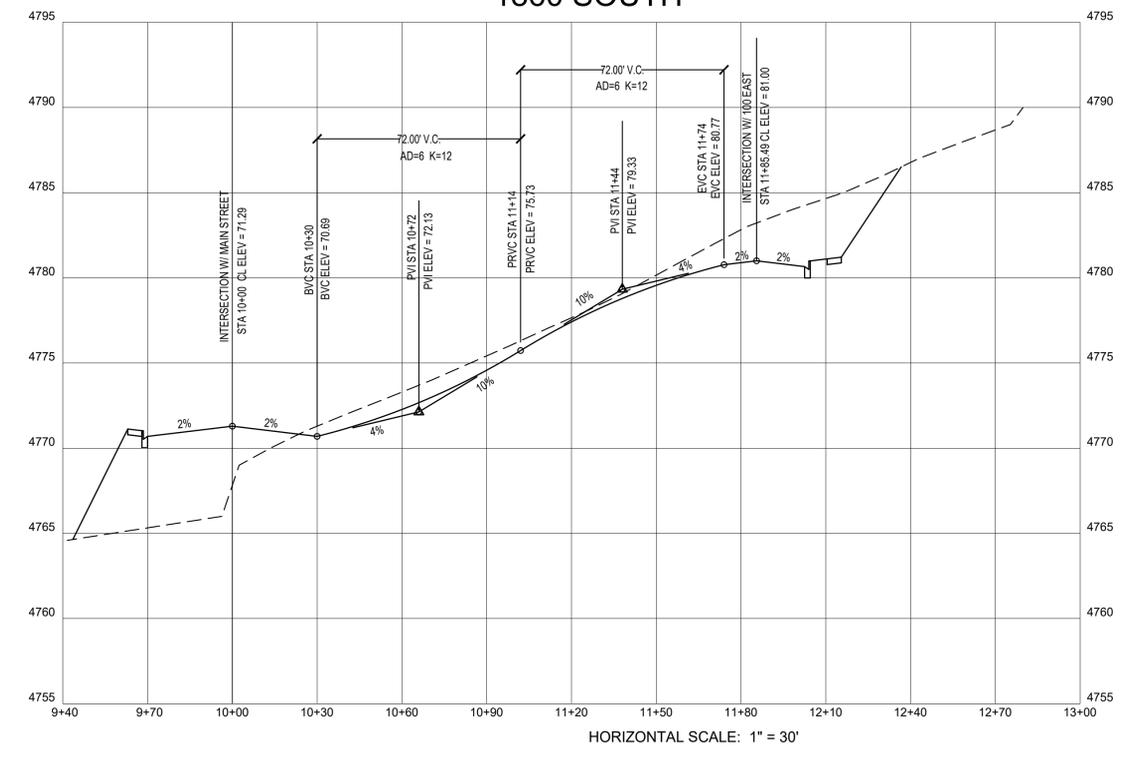

HORIZONTAL SCALE: 1" = 30'

UTILITY DISCLAIMER

The locations, materials, slopes, flow line, rim elevations, and sizes of the existing underground or overhead utilities are shown as accurately as possible, but due to the age of the infrastructure and reporting errors the sizes and locations of the utilities shown on the Payson City GIS map are approximate and should not be used for design purposes. The owner and contractor of a development project are responsible for contacting Blue Stakes to locate all the existing utilities and performing pot holes to field verify the sizes, materials, and depths of the existing utilities prior to construction and ordering the correct materials to prevent errors in design sizes, materials, slopes, flow lines, and rim elevation shown on the GIS map. Failure to verify the sizes and ordering the building the wrong sized pipe or structure is the responsibility of the owner or contractor.

The engineering design of an open channel, pipe system, storm drainage detention/retention system, etc. should include hydraulics and hydrology calculations. Failure to comply with these requirements constitute Unprofessional Conduct under the Utah State Division of Professional Licensing rules and regulations.

INSPECTION, TESTING AND QUALITY CONTROL

- a. All construction work involving the installation of improvements in Payson City shall be subject to City inspections and testing as outlined in the quality control section of each specification.
- b. Request for inspection:
- i. Request for inspections shall be made to the Public Works Secretary by the person responsible for the construction.
- ii. Notice shall be given forty-eight (48) hours in advance of the work starting.
- iii. Any work shall be inspected prior to being backfilled or covered.
- c. Construction completion inspection:
- i. A final inspection shall be made by the Public Works Director, or a designee upon receipt of a request by the owner after all the construction work is completed.
- ii. Any faulty or defective work shall be corrected by the persons responsible for the work within a period of thirty (30) days from the date of the City Engineer's Inspection Report defining the faulty or defective work.
- d. Quality Control Testing:
- i. Material testing shall be conducted by an independent laboratory, approved by the Public Works Director, at the owner's expense. Material testing and inspection fees must be paid in full before requesting a pre- construction meeting.
- ii. All testing shall comply with the current ASTM, AASHTO, AWWA or Public Drinking Water Regulation standards and shall meet the minimum testing requirements as outlined in the specifications.
- iii. Personnel performing test shall have the appropriate certifications to perform such tests.
- iv. The cost of any and all re-testing required to bring materials into specification shall be borne by the owner.
- v. The time and locations of all test shall be approved by the Public Works Director's office.
- vi. If determined necessary by the Public Works Director or a designee, additional material testing can be required.
- e. Test report:
- i. Written test results will be required for review by the Public Works Director after each portion of the work (i.e. pipeline construction, earthwork, curb, gutter and sidewalk, roadway construction, etc.)

AS-BUILT DRAWINGS

- a. Before final inspection, the Contractor shall provide a complete set of as-built drawings that includes all items specified on the construction drawings.
- b. The as-built drawings shall show all improvement dimensions as constructed in the field.
- c. The as-built drawings shall be submitted on a flash drive saved on AutoCAD and Adobe Acrobat format.
- e. No bond retainer shall be released until as-built drawings are received by the Public Works Director.

GUARANTEE OF WORK

- a. The Owner shall warrant and guarantee that the improvements provided for hereunder, and every part thereof, will remain in good condition for a period of one (1) year after the date of the acceptance of the project by the City. Payson City Standard Detail PB 1 illustrates the process for posting performance guarantee bonds.
- b. The Owner shall make all the necessary repairs and maintain the improvements and every part thereof in good condition during the specified time at no cost to the City.
- c. The guarantee hereby stipulated shall extend to and include, but shall not be limited to:
 - i. Road base.
 - ii. Asphalt or concrete pavement.
 - iii. All pipes.
 - iv. Pipe joints.
 - v. Valves.
 - vi. Manholes.
 - vii. Backfill
 - viii. Curb
 - ix. Gutters
 - x. Sidewalks
 - xi. Striping and signage.
- d. Whenever, in the judgment of the Public Works Director, said work shall be in need of repair, maintenance, or reconstruction, written notice shall be served upon the Owner and thereupon the Owner shall undertake and complete such repairs in a timely manner.
- e. If the Owner fails to do so within thirty (30) days from the date of the service of such notice, the Public Works Director shall have such repairs made and the cost of such repairs shall be paid by the Owner including any additional expenses incurred by the City.

TRAFFIC CONTROL AND ROAD CLOSURES

- a. The Contractor shall provide and maintain all necessary signs and barricades needed for traffic control according to the MUTCD guidelines, latest edition.
- b. All necessary precautions shall be taken to protect the work and to safeguard the public.
- c. Street road closures shall be approved by the City Engineer or his designee.
- d. Sidewalk closures shall include a walkable path for people with disabilities.

SURVEY MONUMENTS

- a. Standard survey control monuments shall be installed in all streets to be dedicated for public use.

UPDES STORMWATER PERMIT

- a. A UPDES (Utah Pollutant Discharge Elimination System) Permit from the State of Utah is required for all projects that disturb greater than 1 acre or are less than one (1) acre and part of common plan of development or sale that is greater than 1 acre.

BUILDING PERMITS

- a. No building permit shall be issued for a subdivision until:
 - i. Road base is placed, graded, compacted, and approved on the entire road surface.
 - ii. Curb and gutter is in place.
 - iii. Street signs are installed.
 - iv. All underground utilities are in place, accepted, and functional.
 - v. Fire hydrants are installed and in full operation.
 - vi. It is reasonable to expect the subdivision improvements to be completed prior to the occupancy of the buildings.

CERTIFICATE OF OCCUPANCY

- a. A developer shall not sell any portion of an approved development without informing the prospective buyer or builder that occupancy may not be obtained until all permanent improvements are installed and approved by the City.

PRE CONSTRUCTION MEETING

- a. All work completed in the right of way shall use a qualified contractor.
- i. Contractor shall be licensed in accordance with state laws.
- ii. The City may refuse a contractor from public works construction for any of the following reasons from the past 5 years:
 - 1. Failure to pay suppliers or subcontractors on previous work.
 - 2. Poor communication.
 - 3. Threatening or intimidating communications.
 - 4. Willful and deceptive efforts to perform defective or substandard work.
 - 5. Defective or substandard work on previous projects.
 - 6. Unethical acts.
- iii. Contractor shall have proper insurance.
 - 1. Liability: One million dollars (\$1,000,000) per person, two million dollars (\$2,000,000) per event.
 - 2. Workers Compensation Insurance.
- b. A preconstruction meeting is required on all development or public works construction projects.
- c. Verify the following:
 - i. Land Disturbance Permit has been issued
 - ii. Storm Water Pollution Prevention Plan is approved and UPDES NOI has been issued.
 - iii. Other necessary permits have been obtained.
 - iv. Conveyance of water rights to Payson City has been completed.
 - v. Payment of inspection and material testing fees has been completed.
 - vi. Payson Fire Department Review approval letter signed.
 - vii. When applicable, developer agreements are signed and executed.
 - viii. When applicable, final plat application is approved.
 - ix. When applicable, performance guarantee bond has been posted.
- d. Attendance is required by contractor project manager, site supervisor(s), design engineer, consultants, significant subcontractors, significant suppliers, Public Works Director, Development Engineer, and City Inspectors.
- e. Discuss the following topics:
 - i. Site supervisors and 24-hour contacts.
 - ii. Compliance with OSHA guidelines.
 - iii. Coordination.
 - iv. Schedule.
 - v. Required material testing submittals.
 - vi. Geotechnical issues.
 - vii. Survey issues.
 - viii. Coordination of inspections.
 - ix. Specifications & standards.
 - x. Request for partial and final bond releases.

IMPROVEMENTS SEQUENCE

- a. City improvements shall be installed in the following sequence, unless otherwise directed by the Public Works Director:
 - 1. Rough grading
 - 2. Sanitary Sewer
 - 3. Culinary Water
 - 4. Pressurized Irrigation
 - 5. Storm Sewer
 - 6. Dry Utilities (In Public Right Of Way)
 - 7. Sub Base
 - 8. Curb and Gutter
 - 9. Road Base
 - 10. Asphalt
 - 11. Dry Utilities (In Easements)
 - 12. Sidewalks and Trails
 - 13. Manholes and Valve Collars
 - 14. Survey Monument
 - 15. Street Signs
 - 16. Street Lights
 - 17. Clean Up
- b. Contractors and Developers shall ensure that all the improvement items previous to paving the road are installed, inspected, surveyed, and approved by the City Inspector.
- c. No road cut permits will be issued on new City streets for five (5) years from the date the street was accepted by the City.

DEVELOPMENT

PAYSON VIEW ESTATES PHASE 4

DEVELOPER



11038 N. Highland Blvd Suite 100
Highland, UT 84003
(801) 642-0119



1018 N. Deer Crest Lane
Alpine Ut, 84004
office (801) 492-1277
cell (801) 616-1677

REVISIONS			SEAL
NO.	DATE	DESCRIPTION	THIS DOCUMENT IS INCOMPLETE AND IS RELEASED TEMPORARILY FOR INTERIM REVIEW ONLY. IT IS NOT INTENDED FOR CONSTRUCTION, BIDDING, OR PERMIT PURPOSES. KENNETH R. BERG P.E. SERIAL NO. 343602 DATE: 01/16/2024
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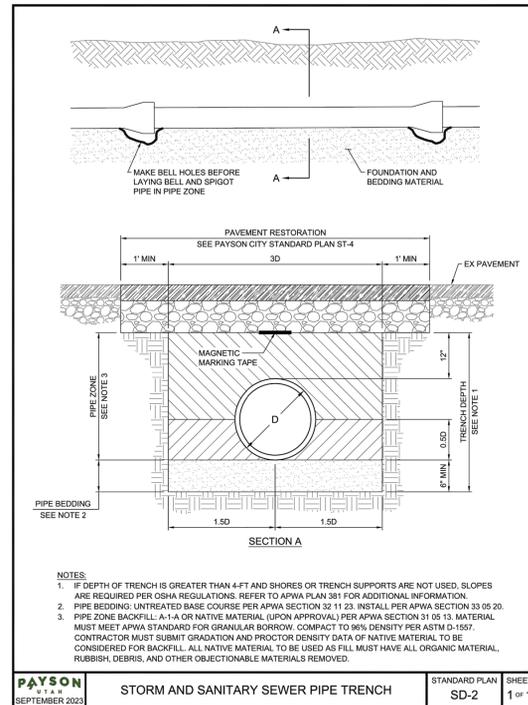
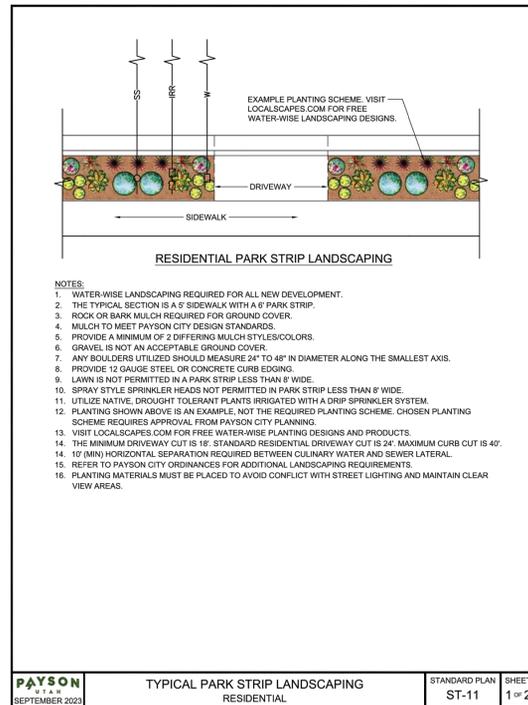
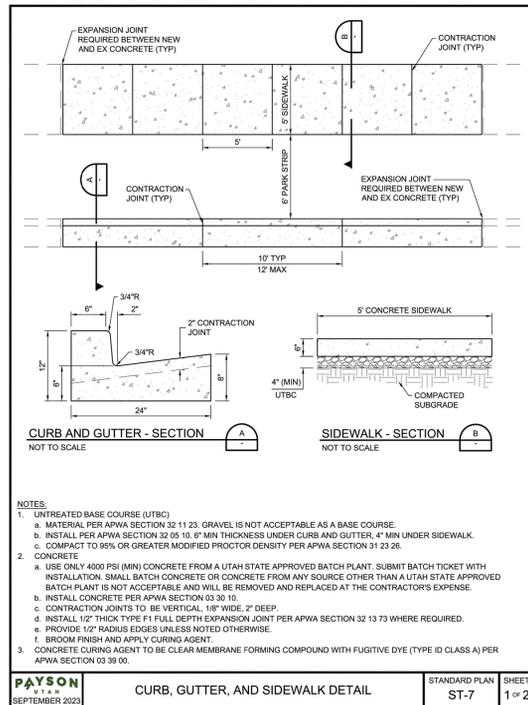
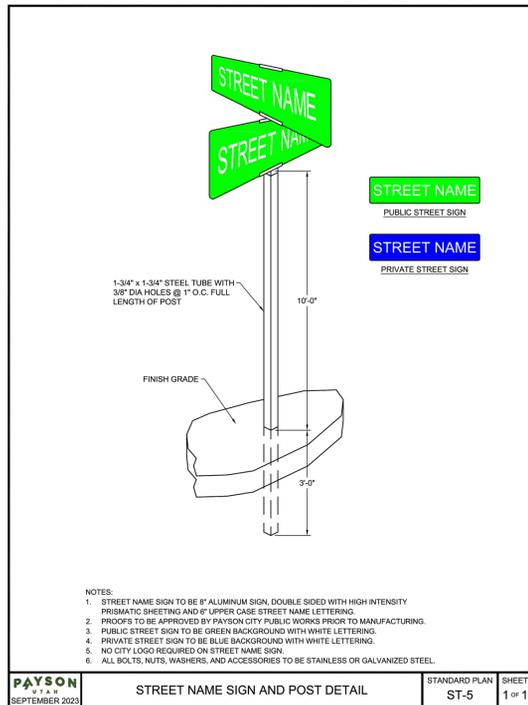
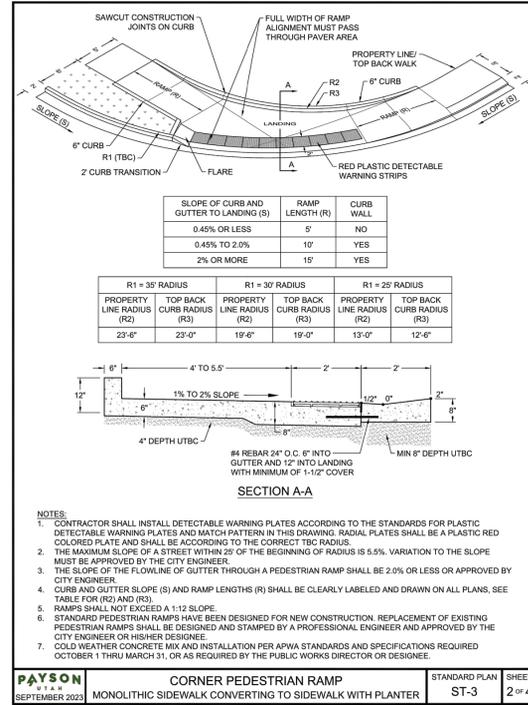
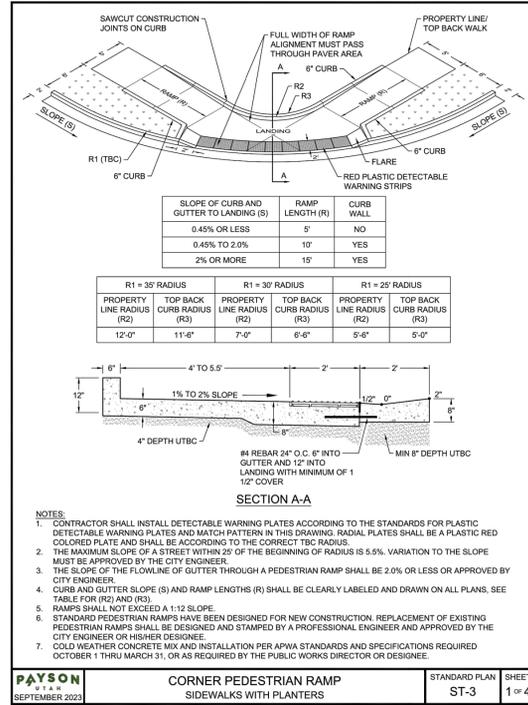
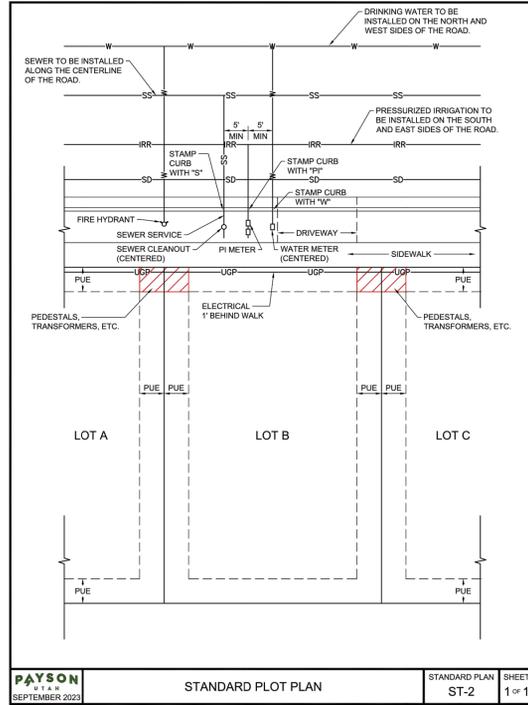
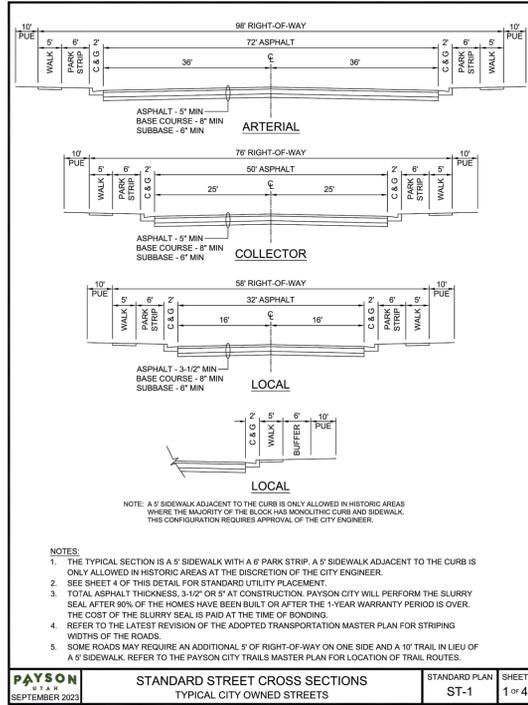
PAYSON VIEW ESTATES PHASE 4

DESCRIPTION

PRELIMINARY PLANS

SHEET NAME SHEET NUMBER

NOTES GN1



DEVELOPMENT

PAYSON VIEW ESTATES PHASE 4

DEVELOPER

www.pnutah.com

11038 N. Highland Blvd Suite 100
Highland, UT 84003
(801) 642-0119

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Alpine, UT, 84004
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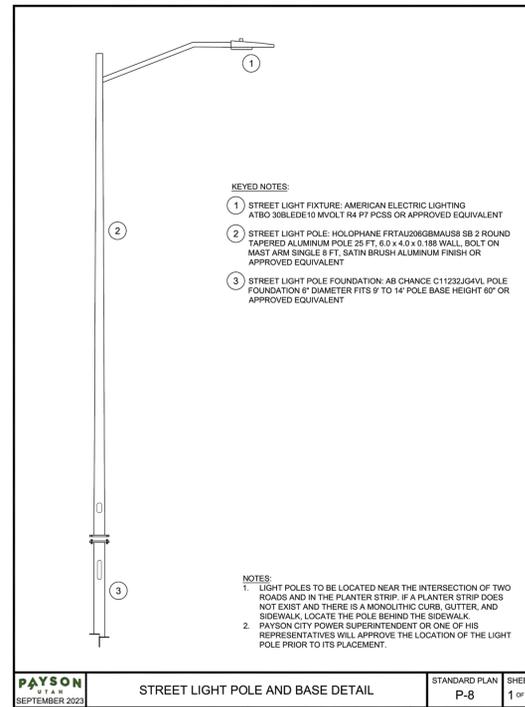
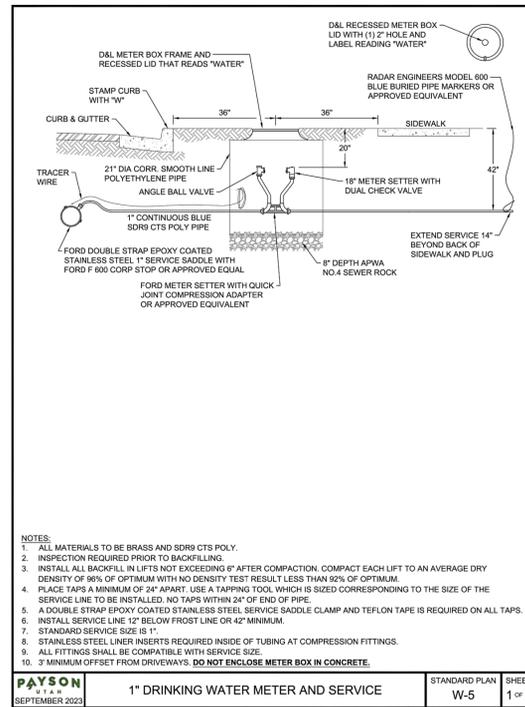
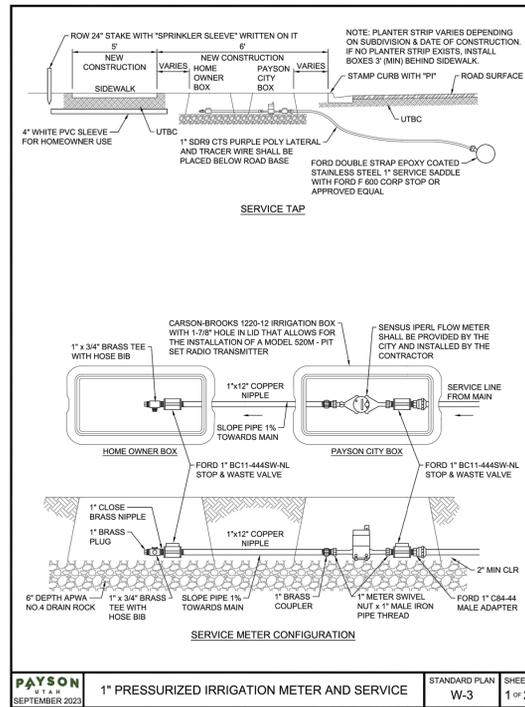
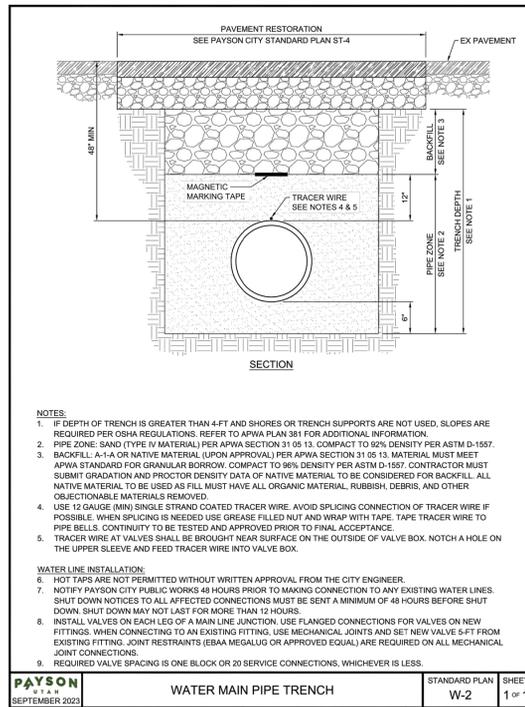
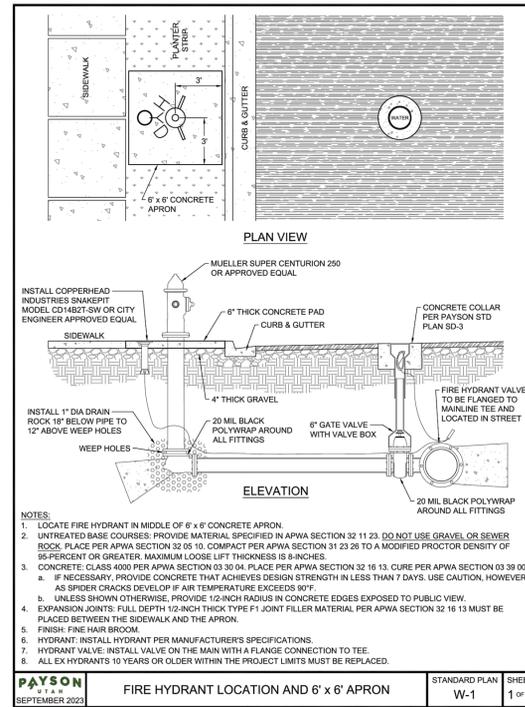
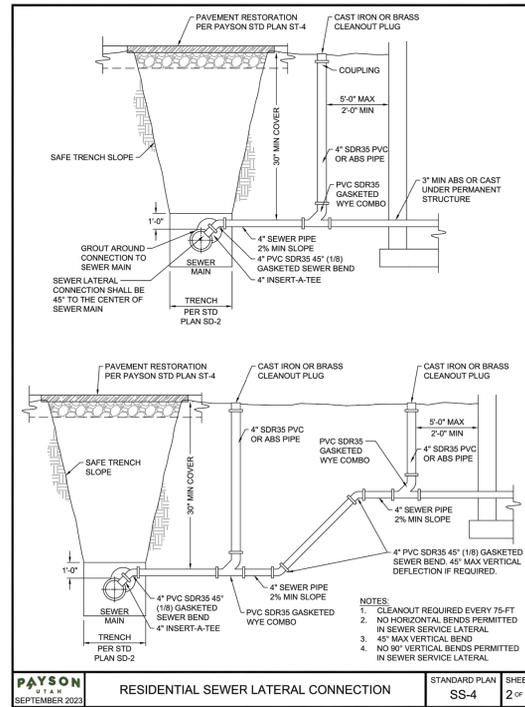
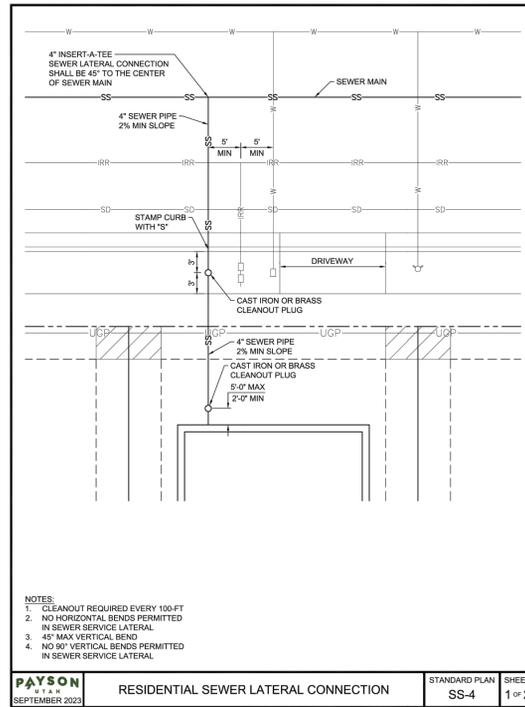
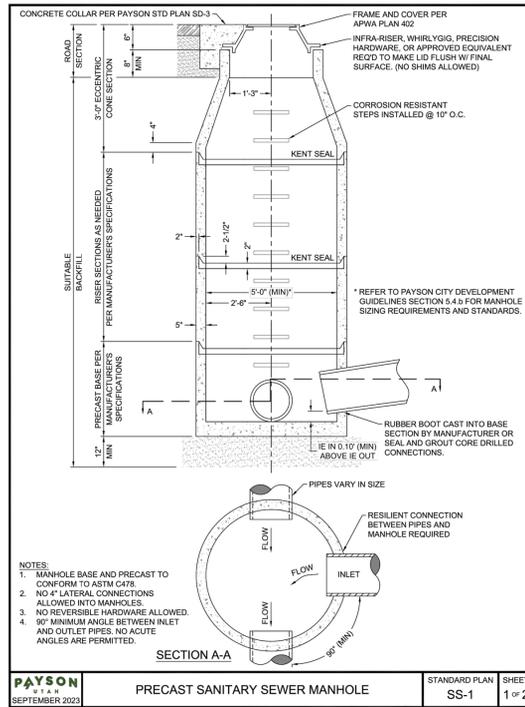
PROJECT

PAYSON VIEW ESTATES PHASE 4

DESCRIPTION

PRELIMINARY PLANS

SHEET NAME	SHEET NUMBER
DETAILS	DTL 1



PAYSON VIEW ESTATES PHASE 4

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Highland, UT 84003
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PAYSON VIEW ESTATES PHASE 4 PRELIMINARY PLANS

SHEET NAME	SHEET NUMBER
DETAILS	DTL2